## TOWN OF BAY HARBOR ISLANDS DEVELOPMENT & REVIEW COMMITTEE MEETING THURSDAY, JANUARY 12, 2023

11:00 A.M.

**CALL TO ORDER:** Set for 11:00 AM

#### PLEDGE OF ALLEGIANCE:

#### **ROLL CALL:**

1. Review and discussion of Site Plan Application by DDG 100 Street BHI, LLC, to construct an 18-unit Multi-Family Development to be located at 1130 - 1140 100 Street. Enclosed are the Site Plans and the Staff Report prepared by Town Planner Michael Miller.

#### ADJOURNMENT:

## APPLICATION FOR SITE PLAN REVIEW



Legal description of real property in the Town of Bay Harbor Islands, Florida for which site plan approval is requested.

LOTS 5 & 6, BLOCK 8, OF BAY HARBOR ISLAND ACCORDING TO THE PLAT THEREOF, AS RECORDED IN PLAT BOOK 46, PAGE 5, OF THE PUBLIC RECORDS OF MIAMI-DADE COUNTY, FLORIDA

THE PERSON NAMED IN	***************************************			
	Folio #13-2227-001-1670/13-222	27-001-1690		***************************************
Town Council	Size of described property150.0' x 150	.0' 22,500 SF		3.
Jordan W. Leonard Mayor	Project Description New Construct		Units	18
Stephanie Bruder Vice Mayor	Owner(s) NameDDG 100th St BHI LI			
Joshua D. Fuller Council Member	Mailing Address138 Pioneer St	***************************************		~
Kelly Reid Council Member	CityBrooklyn			
lsaac Salver Council Member	Phone Number 718-852-8162	Emaille	ee@redhoek.com/e	elliot@redhoek.com
Elizabeth Tricoche Council Member	Signature of Owner			
Robert Yaffe	Name of Applicant (if different from own			***************************************
Council Member	Mailing Address			
Town Officials	City	State	Zip_	***************************************
Ronald J. Wasson Town Manager	Phone Number	Email		
Marlene M. Siegel Town Clerk	Signature of Applicant			***************************************
Craig B. Sherman	Name of Representative			**************************************
Town Attorney	Mailing Address			
b	City	State	Zip	x .
	Phone Number	Email		
		~~~~~~~	nnnnnnnnn	nnnnn
	TO BE COMPLETED BY TO	WN OF BAY I	HARBOR ISLANDS	<u>i</u>
	Date Received	By		***************************************
	Process Number	_ Fee Paid _		


MAYOR JOSEPH J. GARDNER GOVERNMENT CENTER



## **DRAINAGE CALCULATIONS**

## 1130-40 100th Street

## 1130-40 100th Street, Bay Harbor Islands, FL.

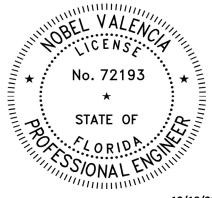

This item has been digitally signed and sealed by Nobel Valencia, P.E., on the date adjacent to the seal.

Printed copies of this document are not considered signed and sealed and the signature must be verified on any electronic copies.

12/18/2022

By: Nobel Valencia, P.E.

12/18/2022

#### COEFFICIENT OF RUNOFF

COEFFICIENT	$\begin{array}{c} \textbf{IMPERVIOUS} \\ (C_i) \end{array}$	ROOF (C <sub>r</sub> )	SWALE (C <sub>s</sub> )	GRASS (C <sub>q</sub> )
	0.9	0.9	0.3	0.3
AREA	IMPERVIOUS (A <sub>i</sub> )	ROOF (A <sub>r</sub> )	SWALE (A <sub>s</sub> )	GRASS (A <sub>g</sub> )
AREA (Sq. Ft.) AREA (Acres)	1561.00 0.04	15209.00 0.35	4042.00 0.09	1688.00 0.04

TOTAL AREA (Sq. Ft.) At = Ai + Ar + As + Ag + Ap Aq Aq Aq At =  $A_t$  =  $A_t$ 

WEIGHTED COEFFICIENT  $C_w = (A_iC_i + A_rC_r + A_sC_s + A_gC_g) / A_t$   $C_w = 0.747$ 

	DESIGN PARAMETERS							
EXFILTRATION TRE	ENCH FOR CATCH BASIN	NS (ON-S	ITE)		GENERAL			
Rainfall Depth (in) 10 year/24 Hr Hydraulic conductivity, (K) cfs / 1 Test #1 Test #2			6.20 20E-04	inches	Total Area of Site (Acres) Flood Zones Base Flood Elevation (FEMA)	= =	0.52 "AE" 9.00	Acres
	Average	1.2	20E-04		Dade County Flood Criteria	=	5.00	NGVD
Depth to Water Table (feet) ** Non-Saturated Trench Depth (fee	(H <sub>2</sub> )		3.20 1.50	feet feet	Water Table Elevation (October H.W.)	=	2.00	NGVD
Saturated Trench Depth (feet) ** Width (feet)	(D <sub>s</sub> ) (W)	1	1.80 4	feet feet	Design Storm	= 10	) year/24	hr
* Information Provided By: * Test Conducted on :	All State Engineering 12/9/2022				Time of Concentration (min.)	=	15	
** Refer to Exfiltration Trench Dia	gram							

#### FORMULAS

VOLUME TREATED (V)  $V = C_w A R$ 

LENGTH OF TRENCH \*\* L= V

 $K(2H_2D_u-D_u^2+2H_2D_s) + 1.39x10^{-4}WD_u$ 

<sup>\*\*</sup> Taken from South Florida Water Management District Permitting Information Manual. Volume IV - 2012.

	DRAINAGE STRUCTURES AREAS										
DRAINAGE AREA NUMBER		ON-SITE	-	-	-	-		-	-		-
Total Impervious Area	$\mathbf{A}_{i}$	1561.00	0.00	0.00	0.00	0.00	0.00	0.00	0.00	0.00	0.00
Total Area of Roof	$A_r$	15209.00	0.00	0.00	0.00	0.00	0.00	0.00	0.00	0.00	0.00
Total Area of Swale	As	4042.00	0.00	0.00	0.00	0.00	0.00	0.00	0.00	0.00	0.00
Total Area of Grass	$\mathbf{A}_{g}$	1688.00	0.00	0.00	0.00	0.00	0.00	0.00	0.00	0.00	0.00
TOTAL AREA (Sq. Ft.)	$A_t$	22500	0	0	0	0	0	0	0	0	0
TOTAL AREA (Acres)	$\mathbf{A}_{t}$	0.52	0.00	0.00	0.00	0.00	0.00	0.00	0.00	0.00	0.00

	EXFILTRATION TRENCH CALCULATIONS										
DRAINAGE AREA NUMBER		ON-SITE	-	-	-	+	+	-	+	+	7
Area (Sq Feet)	Α	22500	0	0	0	0	0	0	0	0	0
Volume Treated (acre-inch)	V	2.39	0.00	0.00	0.00	0.00	0.00	0.00	0.00	0.00	0.00
Trench Width (Feet)	W	4	4	4	4	4	4	4	4	4	4
Hydraulic Conductivity, K	K	1.20E-04									
Depth to Water Table	H <sub>2</sub>	3.2	3.2	3.2	3.2	3.2	3.2	3.2	3.2	3.2	3.2
Non-Saturated Trench Depth (feet)	Du	1.5	1.5	1.5	1.5	1.5	1.5	1.5	1.5	1.5	1.5
Saturated Trench Depth (feet)	D <sub>s</sub>	11.8	11.8	11.8	11.8	11.8	11.8	11.8	11.8	11.8	11.8
Length of Trench Required (ft)	L	222.01	0.00	0.00	0.00	0.00	0.00	0.00	0.00	0.00	0.00
Min. Length of Trench Used (ft)	L	250	0	0	0	0	0	0	0	0	0
	·	•	-			·	·		·		

PROJECT NAME 1130-40 100th Street

#### **ON-SITE Drainage**

PROJECT LOCATION 1130-40 100th Street, Bay Harbor Islands, FL.

DATE December 18, 2022

C FACTOR FOR IMPERVIOUS AREA	0.9
C FACTOR FOR PERVIOUS AREAS	0.3
ACRES OF IMPERVIOUS AREAS	0.38
ACRES OF PERVIOUS AREAS	0.13
LINEAR FEET OF FRENCH DRAIN PROVIDED	250.00
RATE OF EXFILTRATION PER LINEAR FOOT	0.010
WEIGHTED COEFFICIENT OF RUN-OFF	0.75
STORAGE AVAILABLE IN SYSTEM (C.F. PER 1000)	0.65
TOTAL DRAINAGE AREA	0.52

#### TIME TO GENERATE ONE INCH OF RUN-OFF IN MINUTES

VOLUME OF ONE INCH OF RUN-OFF IN C.F.

DESIGN STORM EVENT
INTIAL TIME OF CONCENTRATION

15

TIME TO GENERATE ONE INCH OF RUN-OFF

12.55

TOTAL TIME TO GENERATE ONE INCH OF RUN-OFF

27.55

#### MASS DIAGRAM FOR 5 YEAR STORM

TIME MIN.	INT I/H	RUN-OFF C.F.S.	CUM-RUN. C.F. X 1000
0	0.00	0.00	0.00
5	7.39	2.85	0.86
10	6.74	2.60	1.56
15	6.20	2.39	2.15
20	5.74	2.21	2.66
25	5.34	2.06	3.09
30	4.99	1.93	3.47
40	4.42	1.70	4.09
50	3.96	1.53	4.59
60	3.59	1.39	4.99
90	2.80	1.08	5.84
120	2.30	0.89	6.39
150	1.95	0.75	6.77
180	1.69	0.65	7.05
240	1.34	0.52	7.44
360	0.94	0.36	7.87
480	0.73	0.28	8.10
720	0.50	0.19	8.35
1080	0.34	0.13	8.52
1440	0.26	0.10	8.61

TIME	EXF.	CUM-EXF+ST	STORAGE	TOTAL
MIN.	C.F.S.	CUBIC FEET X 1000		
0	2.49	0.00	0.65	0.65
5	2.49	0.75	0.65	1.40
10	2.49	1.49	0.65	2.14
15	2.49	2.24	0.65	2.89
20	2.49	2.98	0.65	3.63
25	2.49	3.73	0.65	4.38
30	2.49	4.47	0.65	5.12
40	2.49	5.97	0.65	6.62
50	2.49	7.46	0.65	8.11
60	2.49	8.95	0.65	9.60
90	2.49	13.42	0.65	14.07
120	2.49	17.90	0.65	18.55
150	2.49	22.37	0.65	23.02
180	2.49	26.85	0.65	27.50
240	2.49	35.80	0.65	36.45
360	2.49	53.70	0.65	54.35
480	2.49	71.60	0.65	72.25
720	2.49	107.40	0.65	108.05
1080	2.49	161.10	0.65	161.75
1440	2.49	214.80	0.65	215.45

#### SUMMARY OF ACCUMULATED INFLOWS AND OUTFLOWS

TIME MIN.	CUM-RUN	CUM-EXF-+ST CUBIC FEET X 1000	OVERF.
0	0.00	0.65	-0.65
5	0.86	1.40	-0.54
10	1.56	2.14	-0.58
15	2.15	2.89	-0.73
20	2.66	3.63	-0.98
25	3.09	4.38	-1.29
30	3.47	5.12	-1.66
40	4.09	6.62	-2.53
50	4.59	8.11	-3.52
60	4.99	9.60	-4.61
90	5.84	14.07	-8.23
120	6.39	18.55	-12.16
150	6.77	23.02	-16.25
180	7.05	27.50	-20.45
240	7.44	36.45	-29.01
360	7.87	54.35	-46.48
480	8.10	72.25	-64.15
720	8.35	108.05	-99.70
1080	8.52	161.75	-153.23
1440	8.61	215.45	-206.84



## All State Engineering & Testing Consultants, Inc.

TESTING LABORATORIES-ENGINEERS-INSPECTION SERVICES-CHEMISTS-DRILLING-ENVIRONMENTAL SERVICES

December 12, 2022

Elliot Haddad 138 Pioneer Street Brooklyn, NY 11231

RE: 7-Story Condominium

1130-1140 100th Street Bay Harbor Islands, FL 3315

To whom it may concern:

This letter presents the results of All State Engineering & Testing Consultants, Inc. (ASETC) Geotechnical Engineering Study for the above referenced project. The purpose of the geotechnical engineering study was to evaluate the site subsurface conditions and provide foundation recommendations for the project.

#### **Project Description**

Our understanding of the site is based on our observations during our subsurface investigation. Information you provided to us indicates the project consists of the construction of a Proposed 7-Story Condominium Building..

#### Test Method and Subsurface Investigation

The borings were conducted in accordance with procedures outlined for Standard Penetration Test and split spoon sampling of soils by ASTM Method D-1586 as described below.

Two (2) feet long, two (2) inches O.D. split spoon sampler was driven into the ground by successive blows with a 140 lbs hammer dropping thirty (30) inches. The soil sampler was driven two (2) feet at a time (continuous method) then extracted for visual examination and classification of the soil samples.

The number of blows required for one (1) foot penetration of the sample is designated as "N" (known as the standard Penetration Resistance Value). The N Value provides an indication of the relative density of non-cohesive soils and the consistency of cohesive soils. A general evaluation of soils is made from the established correlation between "N" and the relative density or consistency of soils. This dynamic method of soil testing has been widely accepted by foundation engineers and architects to conservatively evaluate the bearing capacity of soils.

The subsurface investigation consisted of performing five (5), 30-ft deep Standard Penetration Test (SPT) borings (B-1, B-2, B-3, B-4, B-5). The borings were performed on December 9, 2022.





# All State Engineering & Testing Consultants, Inc. TESTING LABORATORIES-ENGINEERS-INSPECTION SERVICES-CHEMISTS-DRILLING-ENVIRONMENTAL SERVICES

12949 W Okeechobee Rd, Unit 4, Hialeah Gardens, FL 33018 Office: 305-888-3373 Fax: 305-888-7443 info@allstateengineering.com

# PERCOLATION TEST USUAL OPEN HOLE - CONSTANT HEAD

DATE:	December 9, 2022	Test Number: P-1				
CLIENT:	Elliot Haddad					
CLIENT ADDRESS:	138 Pioneer Street, Brooklyn, NY 11231					
PROJECT:	7-Story Condominium					
PROJECT ADDRESS:	1130-1140 100th Street, Bay Harbor Island, FL 33154					
LOCATION OF TEST:	North Side of Lot					

INTERVAL	ELAPSED TIME (MINUTES)	GPM
1	1:00	6
2	1:00	6
3	1:00	6
4	1:00	6
5	1:00	6
6	1:00	6
7	1:00	6
8	1:00	6
9	1:00	6
10	1:00	6

DIA. OF HOLE: 0.5 feet PERC. RATE: 6.0 GPM **DEPTH OF HOLE:** 15 feet

**DEPTH OF WATER TABLE BELOW GROUND SURFACE:** 6 feet

STABILIZED FLOW RATE: SATURATED HOLE DEPTH: 9 feet 0.013368

> k-VALUE: 1.20E-04

#### SUBSURFACE INVESTIGATION

Depth Below Ground Surface	Soil Description
0'-0" to 3'-0"	Sand with Rock Particles (Backfill)
3'-0" to 8-0"	Beach Sand with Silt and Organics
8'-0" to 15-0"	Gray Beach Sand with Lime Sand Traces

Field Technician: TH Typed by: GO

Respectfully\_Submitted

All State Engineering & Testing



All State Engineering & Testing Consultants, Inc.
TESTING LABORATORIES-ENGINEERS-INSPECTION SERVICES-CHEMISTS-DRILLING-ENVIRONMENTAL SERVICES
12949 W Okeechobee Rd, Unit 4, Hialeah Gardens, FL 33018 Office. 305-888-3373 Fax: 305-888-7443 info@allstateengineering.com

## **PERCOLATION TEST**

#### **USUAL OPEN HOLE - CONSTANT HEAD**

DATE:	December 9, 2022	Test Number:	P-2				
CLIENT:	Elliot Hadded						
CLIENT ADDRESS:	138 Pioneer Street, Brooklyn, NY 11231						
PROJECT:	Single Family Residence						
PROJECT ADDRESS:	1130-1140 100th Street, Bay Harbor Island, FL 33154						
LOCATION OF TEST:	: South Side of Lot						

INTERVAL	ELAPSED TIME (MINUTES)	GPM
1	1:00	4
2	1:00	4
3	1:00	4
4	1:00	4
5	1:00	4
6	1:00	4
7	1:00	4
8	1:00	4
9	1:00	4
10	1:00	4

**DEPTH OF HOLE:** 

15 feet

DIA. OF HOLE:

0.5 feet

PERC. RATE:

4.0 GPM

**DEPTH OF WATER TABLE BELOW GROUND SURFACE: SATURATED HOLE DEPTH:** 

9 feet

STABILIZED FLOW RATE:

6 feet

0.008912

k-VALUE:

8.00E-05

#### SUBSURFACE INVESTIGATION

Depth Below Ground Surface	Soil Description
0'-0" to 3-0"	Sand with Rock Particles (Backfill)
3-0" to 8'-0"	Beach Sand with Silt and Organics
8'-0" to 15'-0"	Beach Sand with Lime Sand Traces SCスグタ

Field Technician: TH

Typed by: GO

Respectfully Submit

All State Engineering & Testin Consultarits Onic


As a mutual protection to clients, the public and ourselves, all reports are submitted as the confidential property of clients. Authorization for publication of statements, conclusions or extracts from or regarding our reports is reserved pending our written approval.



## All State Engineering & Testing Consultants, Inc.

TESTING LABORATORIES-ENGINEERS-INSPECTION SERVICES-CHEMISTS-DRILLING-ENVIRONMENTAL SERVICES 12949 West Okeechobee Rd, Hialeah Gardens, Florida 33018 / Phone: 305-888-3373 Fax: 305-888-7443

## Boring Location Map 1130-1140 100th Street, Bay Harbor Islands, FL 33154

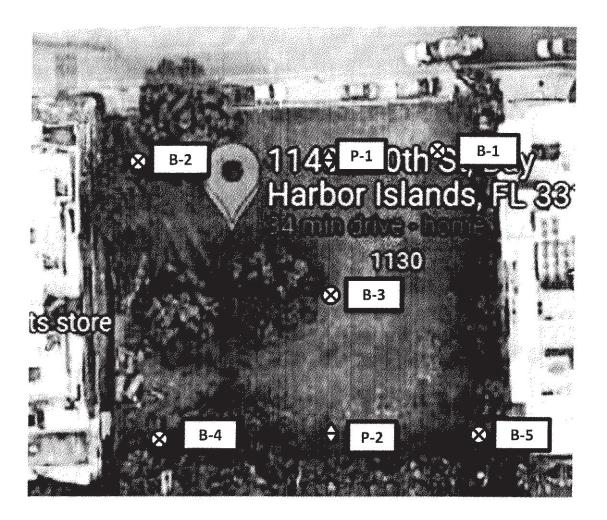

## Legend

- **⊗** Boring Location
- ♦ Percolation Location







## **ICC-ES Evaluation Report**

ICC-ES | (800) 423-6587 | (562) 699-0543 | www.icc-es.org

**ESR-2074** 

Reissued 02/2021 Revised 04/2021 This report is subject to renewal 02/2023.

**DIVISION: 08 00 00—OPENINGS** 

SECTION: 08 95 43—VENTS/FOUNDATION FLOOD VENTS

#### **REPORT HOLDER:**

### **SMART VENT PRODUCTS, INC.**

#### **EVALUATION SUBJECT:**

SMART VENT® AUTOMATIC FOUNDATION FLOOD VENTS: MODELS #1540-520; #1540-521; #1540-510; #1540-511; #1540-570; #1540-574; #1540-524; #1540-514 FLOOD VENT SEALING KIT #1540-526



"2014 Recipient of Prestigious Western States Seismic Policy Council (WSSPC) Award in Excellence"

A Subsidiary of CODE COUNCIL

ICC-ES Evaluation Reports are not to be construed as representing aesthetics or any other attributes not specifically addressed, nor are they to be construed as an endorsement of the subject of the report or a recommendation for its use. There is no warranty by ICC Evaluation Service, LLC, express or implied, as to any finding or other matter in this report, or as to any product covered by the report.





### **ICC-ES Evaluation Report**

**ESR-2074** 

Reissued February 2021 Revised April 2021 This report is subject to renewal February 2023.

www.icc-es.org | (800) 423-6587 | (562) 699-0543

A Subsidiary of the International Code Council®

**DIVISION: 08 00 00—OPENINGS** 

Section: 08 95 43—Vents/Foundation Flood Vents

**REPORT HOLDER:** 

SMART VENT PRODUCTS, INC.

#### **EVALUATION SUBJECT:**

SMART VENT® AUTOMATIC FOUNDATION FLOOD VENTS: MODELS #1540-520; #1540-521; #1540-510; #1540-511; #1540-570; #1540-574; #1540-524; #1540-514 FLOOD VENT SEALING KIT #1540-526

#### 1.0 EVALUATION SCOPE

#### Compliance with the following codes:

- 2021, 2018, 2015, 2012, 2009 and 2006 International Building Code<sup>®</sup> (IBC)
- 2021, 2018, 2015, 2012, 2009 and 2006 International Residential Code<sup>®</sup> (IRC)
- 2021, 2018 International Energy Conservation Code® (IECC)
- 2013 Abu Dhabi International Building Code (ADIBC)<sup>†</sup>

<sup>†</sup>The ADIBC is based on the 2009 IBC. 2009 IBC code sections referenced in this report are the same sections in the ADIBC.

#### Properties evaluated:

- Physical operation
- Water flow

#### **2.0 USES**

The Smart Vent® units are engineered mechanically operated flood vents (FVs) employed to equalize hydrostatic pressure on walls of enclosures subject to rising or falling flood waters. Certain models also allow natural ventilation.

#### 3.0 DESCRIPTION

#### 3.1 General:

When subjected to rising water, the Smart Vent® FVs internal floats are activated, then pivot open to allow flow in either direction to equalize water level and hydrostatic pressure from one side of the foundation to the other. The FV pivoting door is normally held in the closed position by a buoyant release device. When subjected to rising water, the buoyant release device causes the unit to unlatch, allowing the door to rotate out of the way and allow flow. The water level stabilizes, equalizing the lateral forces. Each unit is

fabricated from stainless steel. Smart Vent® Automatic Foundation Flood Vents are available in various models and sizes as described in Table 1. The SmartVENT® Stacking Model #1540-511 and FloodVENT® Stacking Model #1540-521 units each contain two vertically arranged openings per unit.

#### 3.2 Engineered Opening:

The FVs comply with the design principle noted in Section 2.7.2.2 and Section 2.7.3 of ASCE/SEI 24-14 [Section 2.6.2.2 of ASCE/SEI 24-05 (2012, 2009, 2006 IBC and IRC)] for a maximum rate of rise and fall of 5.0 feet per hour (0.423 mm/s). In order to comply with the engineered opening requirement of ASCE/SEI 24, Smart Vent FVs must be installed in accordance with Section 4.0.

#### 3.3 Ventilation:

The SmartVENT® Model #1540-510 and SmartVENT® Overhead Door Model #1540-514 both have screen covers with ¹/₄-inch-by-¹/₄-inch (6.35 by 6.35 mm) openings, yielding 51 square inches (32 903 mm²) of net free area to supply natural ventilation. The SmartVENT® Stacking Model #1540-511 consists of two Model #1540-510 units in one assembly, and provides 102 square inches (65 806 mm²) of net free area to supply natural ventilation. Other FVs described in this report do not offer natural ventilation.

#### 3.4 Flood Vent Sealing Kit:

The Flood Vent Sealing Kit Model #1540-526 is used with SmartVENT® Model #1540-520. It is a Homasote 440 Sound Barrier® (ESR-1374) insert with 21 - 2-inch-by-2-inch (51 mm x 51 mm) squares cut in it. See Figure 4.

#### 4.0 DESIGN AND INSTALLATION

#### 4.1 SmartVENT® and FloodVENT®:

SmartVENT® and FloodVENT® are designed to be installed into walls or overhead doors of existing or new construction from the exterior side. Installation of the vents must be in accordance with the manufacturer's instructions, the applicable code and this report. Installation clips allow mounting in masonry and concrete walls of any thickness. In order to comply with the engineered opening design principle noted in Section 2.7.2.2 and 2.7.3 of ASCE/SEI 24-14 [Section 2.6.2.2 of ASCE/SEI 24-05 (2012, 2009, 2006 IBC and IRC)], the Smart Vent® FVs must be installed as follows:

With a minimum of two openings on different sides of each enclosed area.



- With a minimum of one FV for every 200 square feet (18.6 m²) of enclosed area, except that the SmartVENT® Stacking Model #1540-511 and FloodVENT® Stacking Model #1540-521 must be installed with a minimum of one FV for every 400 square feet (37.2 m²) of enclosed area.
- Below the base flood elevation.
- With the bottom of the FV located a maximum of 12 inches (305.4 mm) above the higher of the final grade or floor and finished exterior grade immediately under each opening.

#### 4.2 Flood Vent Sealing Kit

The Flood Vent Sealing Kit Model 1540-526 is used in conjunction with FloodVENT® Model #1540-520. When installed and tested in accordance with ASTM E283, the FV and Flood Vent Sealing Kit assembly have an air leakage rate of less than 0.2 cubic feet per minute per lineal foot (18.56 l/min per lineal meter) at a pressure differential of 1 pound per square foot (50 Pa) based on 12.58 lineal feet (3.8 lineal meters) contained by the Flood Vent Sealing Kit.

#### 5.0 CONDITIONS OF USE

The Smart Vent® FVs described in this report comply with, or are suitable alternatives to what is specified in, those codes listed in Section 1.0 of this report, subject to the following conditions:

5.1 The Smart Vent® FVs must be installed in accordance with this report, the applicable code and the manufacturer's installation instructions. In the event of a conflict, the instructions in this report govern. 5.2 The Smart Vent® FVs must not be used in the place of "breakaway walls" in coastal high hazard areas, but are permitted for use in conjunction with breakaway walls in other areas.

#### 6.0 EVIDENCE SUBMITTED

- **6.1** Data in accordance with the ICC-ES Acceptance Criteria for Mechanically Operated Flood Vents (AC364), dated August 2015 (editorially revised February 2021).
- **6.2** Test report on air infiltration in accordance with ASTM E283.

#### 7.0 IDENTIFICATION

- 7.1 The Smart VENT® models and the Flood Vent Sealing Kit described in this report must be identified by a label bearing the manufacturer's name (Smartvent Products, Inc.), the model number, and the evaluation report number (ESR-2074).
- **7.2** The report holder's contact information is the following:

SMART VENT PRODUCTS, INC. 430 ANDBRO DRIVE, UNIT 1 PITMAN, NEW JERSEY 08071 (877) 441-8368

www.smartvent.com info@smartvent.com

**TABLE 1—MODEL SIZES** 

MODEL NAME	MODEL NUMBER	MODEL SIZE (in.)	COVERAGE (sq. ft.)
FloodVENT®	1540-520	15 <sup>3</sup> / <sub>4</sub> " X 7 <sup>3</sup> / <sub>4</sub> "	200
SmartVENT®	1540-510	15 <sup>3</sup> / <sub>4</sub> " X 7 <sup>3</sup> / <sub>4</sub> "	200
FloodVENT® Overhead Door	1540-524	15 <sup>3</sup> / <sub>4</sub> " X 7 <sup>3</sup> / <sub>4</sub> "	200
SmartVENT® Overhead Door	1540-514	15 <sup>3</sup> / <sub>4</sub> " X 7 <sup>3</sup> / <sub>4</sub> "	200
Wood Wall FloodVENT®	1540-570	14" X 8 <sup>3</sup> / <sub>4</sub> "	200
Wood Wall FloodVENT® Overhead Door	1540-574	14" X 8 <sup>3</sup> / <sub>4</sub> "	200
SmartVENT® Stacker	1540-511	16" X 16"	400
FloodVent® Stacker	1540-521	16" X 16"	400

For SI: 1 inch = 25.4 mm; 1 square foot = m<sup>2</sup>

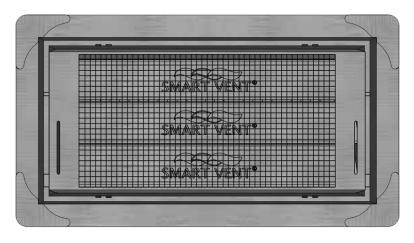


FIGURE 1—SMART VENT: MODEL 1540-510

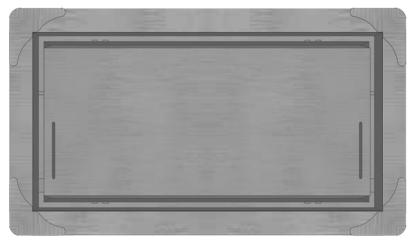


FIGURE 2—SMART VENT MODEL 1540-520



FIGURE 3—SMART VENT: SHOWN WITH FLOOD DOOR PIVOTED OPEN

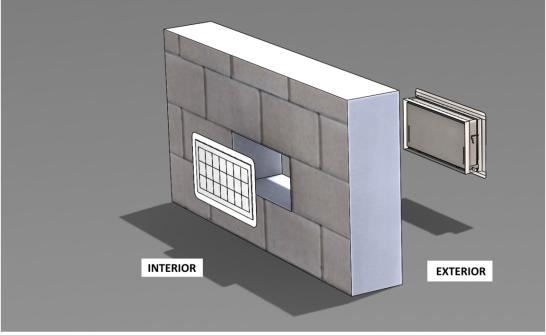


FIGURE 4—FLOOD VENT SEALING KIT



### **ICC-ES Evaluation Report**

### **ESR-2074 CBC and CRC Supplement**

Reissued February 2021 Revised April 2021 This report is subject to renewal February 2023.

www.icc-es.org | (800) 423-6587 | (562) 699-0543

A Subsidiary of the International Code Council®

**DIVISION: 08 00 00—OPENINGS** 

Section: 08 95 43—Vents/Foundation Flood Vents

**REPORT HOLDER:** 

SMART VENT PRODUCTS, INC.

#### **EVALUATION SUBJECT:**

SMART VENT® AUTOMATIC FOUNDATION FLOOD VENTS: MODELS #1540-520; #1540-521; #1540-510; #1540-511; #1540-570; #1540-574; #1540-524; #1540-524; #1540-526

#### 1.0 REPORT PURPOSE AND SCOPE

#### Purpose:

The purpose of this evaluation report supplement is to indicate that Smart Vent® Automatic Foundation Flood Vents, described in ICC-ES evaluation report ESR-2074, have also been evaluated for compliance with codes noted below.

#### Applicable code editions:

■ 2019 California Building Code (CBC)

For evaluation of applicable chapters adopted by the California Office of Statewide Health Planning and Development (OSHPD) and Division of State Architect (DSA), see Sections 2.1.1 and 2.1.2 below.

■ 2019 California Residential Code (CRC)

#### 2.0 CONCLUSIONS

#### 2.1 CBC:

The Smart Vent® Automatic Foundation Flood Vents, described in Sections 2.0 through 7.0 of the evaluation report ESR-2074, comply with 2019 CBC Chapter 12, provided the design and installation are in accordance with the 2018 *International Building Code*® (IBC) provisions noted in the evaluation report and the additional requirements of CBC Chapters 12 and 16, as applicable.

#### 2.1.1 OSHPD:

The applicable OSHPD Sections and Chapters of the CBC are beyond the scope of this supplement.

#### 2.1.2 DSA:

The applicable DSA Sections and Chapters of the CBC are beyond the scope of this supplement.

#### 2.2 CRC:

The Smart Vent® Automatic Foundation Flood Vents, described in Sections 2.0 through 7.0 of the evaluation report ESR-2074, comply with the 2019 CRC, provided the design and installation are in accordance with the 2018 *International Residential Code*® (IRC) provisions noted in the evaluation report.

This supplement expires concurrently with the evaluation report, reissued February 2021 and revised April 2021.





### **ICC-ES Evaluation Report**

### **ESR-2074 FBC Supplement**

Reissued February 2021 Revised April 2021 This report is subject to renewal February 2023.

www.icc-es.org | (800) 423-6587 | (562) 699-0543

A Subsidiary of the International Code Council®

**DIVISION: 08 00 00—OPENINGS** 

Section: 08 95 43—Vents/Foundation Flood Vents

**REPORT HOLDER:** 

SMART VENT PRODUCTS, INC.

**EVALUATION SUBJECT:** 

SMART VENT® AUTOMATIC FOUNDATION FLOOD VENTS: MODELS #1540-520; #1540-521; #1540-510; #1540-511; #1540-570; #1540-574; #1540-524; #1540-514 FLOOD VENT SEALING KIT #1540-526

#### 1.0 REPORT PURPOSE AND SCOPE

#### Purpose:

The purpose of this evaluation report supplement is to indicate that Smart Vent® Automatic Foundation Flood Vents, described in ICC-ES evaluation report ESR-2074, have also been evaluated for compliance with the codes noted below.

#### Applicable code editions:

- 2020 Florida Building Code—Building
- 2020 Florida Building Code—Residential

#### 2.0 CONCLUSIONS

The Smart Vent® Automatic Foundation Flood Vents, described in Sections 2.0 through 7.0 of the evaluation report ESR-2074, comply with the *Florida Building Code—Building* and the *Florida Building Code-Residential*, provided the design requirements are determined in accordance with the *Florida Building Code-Building* or the *Florida Building Code-Residential*, as applicable. The installation requirements noted in ICC-ES evaluation report ESR-2074 for 2018 *International Building Code®* meet the requirements of the *Florida Building Code-Building* or the *Florida Building Code-Residential*, as applicable.

Use of the Smart Vent® Automatic Foundation Flood Vents has also been found to be in compliance with the High-Velocity Hurricane Zone provisions of the *Florida Building Code—Building* and the *Florida Building Code—Residential*.

For products falling under Florida Rule 61G20-3, verification that the report holder's quality assurance program is audited by a quality assurance entity approved by the Florida Building Commission for the type of inspections being conducted is the responsibility of an approved validation entity (or the code official when the report holder does not possess an approval by the Commission).

This supplement expires concurrently with the evaluation report, reissued February 2021 and revised April 2021.



### Erin Santiago

Arborist FL-5705A | LIAF Inspector #2018-0214 The Santiago Group LLC <u>thesantiagogroupllc@gmail.com</u> (954) 947-1087

December 13, 2022

#### **ISA Certified Arborist Report**

The following is an arborist report for 1130 and 1140 100th Street in Bay Harbor Islands, Florida. The purpose of this report is to inventory and evaluate the condition of the trees. This report is not a risk assessment on a Level 2 or 3 as described by the Levels and Scope of Tree Risk Assessment from the ANSI A300 Part 9: Tree, shrub, and Other Woody Plant Management – Standard Practices. The Santiago Group LLC cannot be held liable for damage to the tree or damage caused by the tree.

#### **Methods:**

The on-site visual inspection at ground level was made on December 6, 2022, to observe the trees. The size of each tree was measured as diameter at breast height (DBH), breast height being 4.5 feet above ground utilizing diameter measure tape. Tree heights and canopy diameters were estimated in feet. Some DBH measurements were estimated when access to the tree could not be obtained. This report describes all the trees within the requested area as well as some trees in the nearby vicinity. Proposed actions are not addressed in this report. The condition rating of each tree is described as Good, Moderate, or Poor. Please refer to ANSI A300 (Part 5)-2012: Management - Annex A-2 for an explanation of non-numeric condition ratings used herein. The TPZs for trees specified in this report were calculated utilizing the ANSI formula and are sufficient to maintain Critical Root Zones (CRZs) as well as the TPZs. TPZs for palms are the arborist's opinion not utilizing the ANSI Formula.


#### **Appendixes:**

Please see Appendix A for Tree Locations, Appendix B for Tree Inventory and Condition Assessment, Appendix C for Photographs and Appendix D for Tree Protection Specifications.

Respectfully submitted,

Erin Santiago, ISA Certified Arborist FL-5705A | LIAF Inspector #2018-0214

## **Appendix A: Tree Locations**

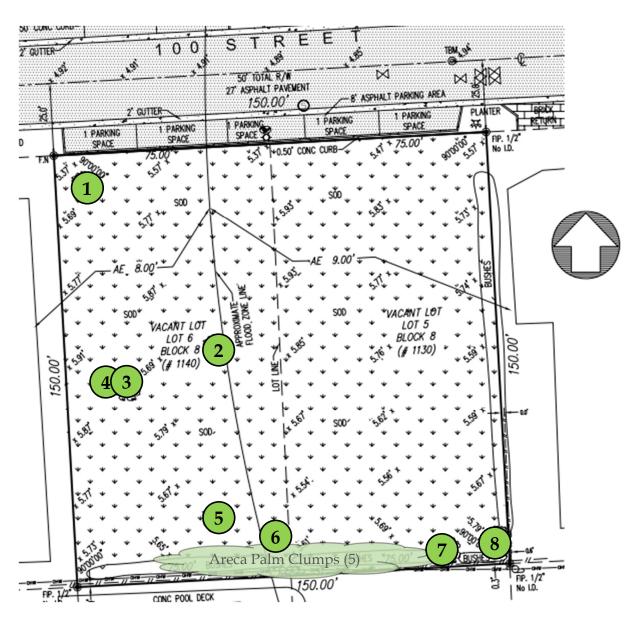


## Appendix B: Tree Inventory and Condition Assessment

Tree	Common	Botanical	DBH	Height	Canopy Diameter	TPZ	TPZ Radius		
#	Name	Name	(inches)	(feet)	(feet)	Factor	(feet)	Condition	Notes
1	Melaleuca	Melaleuca quinquenervia	85	33	45	10	71	Moderate	Class 1 invasive. Recommend removal.  Multistem codominant. Strangler fig volunteer is growing from the center which will further impact structure.
2	Strangler Fig	Ficus aurea	72	34	50	10	60	Moderate	Good canopy balance but voids created by live melaleuca foliage. Live melaleuca within its structure and has been the scaffold. Insect impact to foliage. Many damaged areas in the melaleuca should be managed. Not an ideal candidate for relocation because of the melaleuca.
3	Strangler Fig	Ficus aurea	30	35	35	10	25	Moderate	Not an ideal candidate for relocation due to tree 4 being live scaffold. Both trees are alive and representing approximately 50% of the structure. Insect impact to foliage.
4	Melaleuca	Melaleuca quinquenervia	30	35	35	10	25	Poor	Class 1 invasive. Recommend removal. Likely in decline.
5	Mango Tree	Mangifera indica	27	18	26	10	23	Moderate	Multistem codominant with mediocre wound response.
6	Brazilian Pepper	Schinus terebinthifolia	15	20	18	10	13	Poor	Class 1 invasive. Recommend removal. Poor structure.
7	Strangler Fig	Ficus aurea	5	22	10	10	4	Poor	Structure impacted by competition. Canopy distributed to the north.
8	Carrotwood	Cupaniopsis anacardiodes	10	24	18	10	8	Poor	Class 1 invasive. Recommend removal.  Major trunk wound with decay.

## Appendix C: Photographs





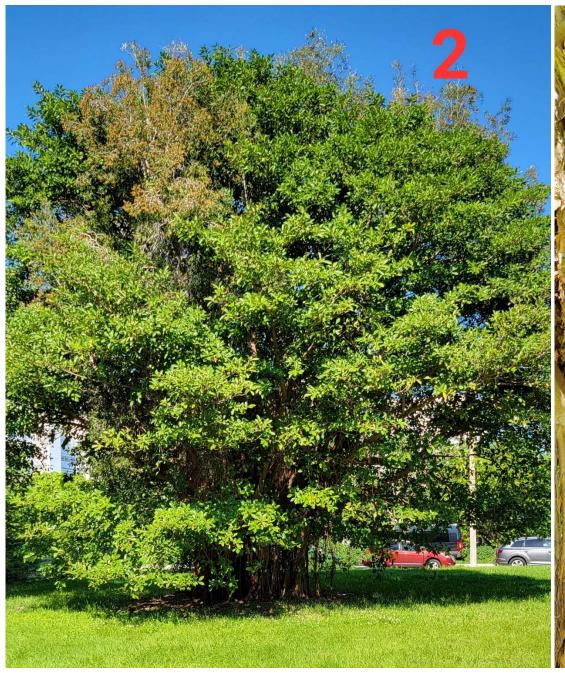
















#### Appendix D: Tree Protection Detail

- A. In instances where the recommended Tree Protection Zone extends over existing hardscape such as sidewalk or driveway, it may not be possible to fence the extent of the TPZ and an arborist's opinion of the extent of fencing should be sought.
- B. There may be instances where site features are proposed to be installed within the TPZ. In instances where work must be performed within the TPZ, work shall be performed under supervision of the arborist or a landscape architect and determined to be safe for the tree due to position of structural roots and ensuring likelihood of proper availability of water and gas exchange. These features will be field located at time of installation to accommodate structural roots.
- C. Recommended footage from base of trunk mentioned in matrices is an estimate only. Arborist should be consulted for direction on root pruning or protection zone changes if excavation reveals significant roots during the course of the project.
- D. TPZ is sufficient to account for CRZ.
- E. TPZ is a radius in feet measured from the root flare outward.

TREE / PALM PROTECTION FENCES SHALL BE CONSTRUCTED PRIOR TO ANY CONSTRUCTION ACTIVITY INCLUDING GRUBBING FOR ALL TREES / PALMS THAT ARE 'TO REMAIN, BE PROTECTED, or BE RELOCATED'

NO ACTIVITY OR DISTURBANCE SHOULD OCCUR WITHIN THE FENCED AREAS, INCLUDING VEHICLE USE, STORAGE OF MATERIALS, DUMPING OF LIQUIDS OR MATERIALS, GRADE CHANGES, GRUBBING, AND MECHANICAL TRENCHING FOR IRRIGATION, ELECTRICAL, LIGHTING, ETC.

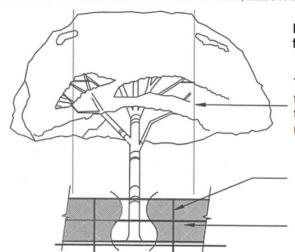

In no case shall the fence be installed less than ten feet from the trunk

Tree + Palm protection barriers to extend beyond the 'dripline' or to the 'critical root zone area' of all trees/palms to be protected. Extend where necessary to protect tree canopy roots

Barriers shall be a minimum of four feet high, and shall be constructed of continuous chain link fence with metal posts at eight-foot spacing, or of two-by-four-inch posts with three equally spaced two-by-four-inch rails. Posts may be shifted to avoid roots.

#### PROTECTION DETAIL NOTE

CONTRACTOR TO INSTALL TREE / PALM PROTECTION FENCE BARRIERS' AROUND ALL EXISTING TREES OR PALMS AT THE START OF THE PROJECT. BARRIERS TO REMAIN IN PLACE THROUGHOUT THE DURATION OF THE PROJECT AND SHOULD NOT BE REMOVED OR DROPPED FOR ANY REASON WITHOUT AUTHORIZATION FROM THE CITY OF MIAMI BEACH URBAN FORESTER + PLANNING + ZONING DEPARTMENT

## C.M.B. TREE / PALM PROTEC. DETAIL



# BHI 1130-1140 100TH ST SITE PLAN REVIEW SUBMISSION

DEC 29, 2022

1130-1140 100TH STREET, BAY HARBOR ISLANDS, FL 33154

# DRAWING LIST

T-01	COVER SHEET
A-01	EXTERIOR RENDERING
A-02	EXTERIOR RENDERING
A-03	EXTERIOR RENDERING
A-04	AERIAL RENDERING
A-05	SITE AND CONTEXT PHOTOGRAPHS
A-06	SITE PLAN AND ZONING INFOMRATION
A-11	FLOOR PLAN - 1ST FLOOR
A-12	FLOOR PLAN - 2ND FLOOR
A-13	FLOOR PLAN - 3RD FLOOR
A-14	FLOOR PLAN - 4TH FLOOR
A-15	FLOOR PLAN - 5TH FLOOR
A-16	FLOOR PLAN - 6TH FLOOR
A-17	FLOOR PLAN - 7TH FLOOR
A-18	FLOOR PLAN - ROOF FLOOR
A-21	EXTERIOR ELEVATION - NORTH
A-22	EXTERIOR ELEVATION - SOUTH
A-23	EXTERIOR ELEVATION - EAST
A-24	EXTERIOR ELEVATION - WEST
A-31	COLOR EXTERIOR ELEVATION - NORTH
A-32	COLOR EXTERIOR ELEVATION - SOUTH
A-33	COLOR EXTERIOR ELEVATION - EAST
A-34	COLOR EXTERIOR ELEVATION - WEST
A-41	BUILDING SECTION
00.41	
CIVIL	OOVED CHIEFT
PD-1	COVER SHEET
PD-2	PAVING, GRADING, DRAINAGE PLANS&TYPICAL SECTION
PD-3	DRAINAGE&PAVEMENT DETAILS
WS-1	COVER SHEET
WS-1 WS-2	WATER&SEWER PLAN&DETAILS
WS-2 WS-3	WATER&SEWER PLAN&DETAILS  WATER&SEWER DETAILS
¥¥ ∪ <sup>-</sup> ∪	WATERIOUS
 LANDSCAPE	
L-02	1ST & 2ND FLOOR PLANTING PLAN
L-03	5TH FLOOR & ROOF PLANTING PLAN
L-04	PLANTING PALETTE
	, Butting (ALLITE
PHOTOMETIC STUDIES	
PS-01	1ST FLOOR PHOTOMETRIC, Normal Power
PS-02	1ST FLOOR PHOTOMETRIC, Emergency Power
PS-03	2ND FLOOR PHOTOMETIC, Normal Power
PS-04	2ND FLOOR PHOTOMETIC, Emergency Power
PS-05	5TH FLOOR PHOTOMETRIC, Normal Power
PS-06	5TH FLOOR PHOTOMETRIC, Emergency Power
PS-07	ROOF PHOTOMETRIC, Normal Power
1 3-01	TIOU THOTOWILITIE, INCHINATION

BHI 1130-1140 100TH ST

1130-1140 100TH STREET, BAY HARBOR ISLANDS, FL 33154

DEVELOPER: Redhoek + Partners

138 PIONEER STREET BROOKLYN, NY 11231 T: 718.852.8162

DESIGNER: Fab 314 architecture workshop HAYESOD STREET 2 #121 TEL AVIV-YAFO, 6816721, IL T: 972-50-888-2629

DESIGNER: PLISKIN ARCHITECTURE PLLC 233 BROADWAY, SUITE 2030

NEW YORK, NY 10279 T: 212-899-9885

ARCHITECT:
CARL LEVIN ARCHITECTURE + DESIGN
3390 MARY STREET, SUITE 135
COCONUT GROVE, FL 33133


T: 305 442 3118 CIVIL: Nga engineers inc. 11231 SW 88TH ST., UNIT D-114

MIAMI, FL 33176 T: 305 200 6701 LANDSCAPE: Strata Landscape architecture 1906 Tigertail Ave


MIAMI, FL 33133 T: 305 747 9336

LIGHTING: Power & Lighting Systems, inc. 3832 SHIPPING AVE. MIAMI, FL 33146 T: 305 444 8520

DOB APPROVAL STAMP

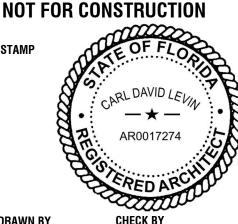

**COVER SHEET** 

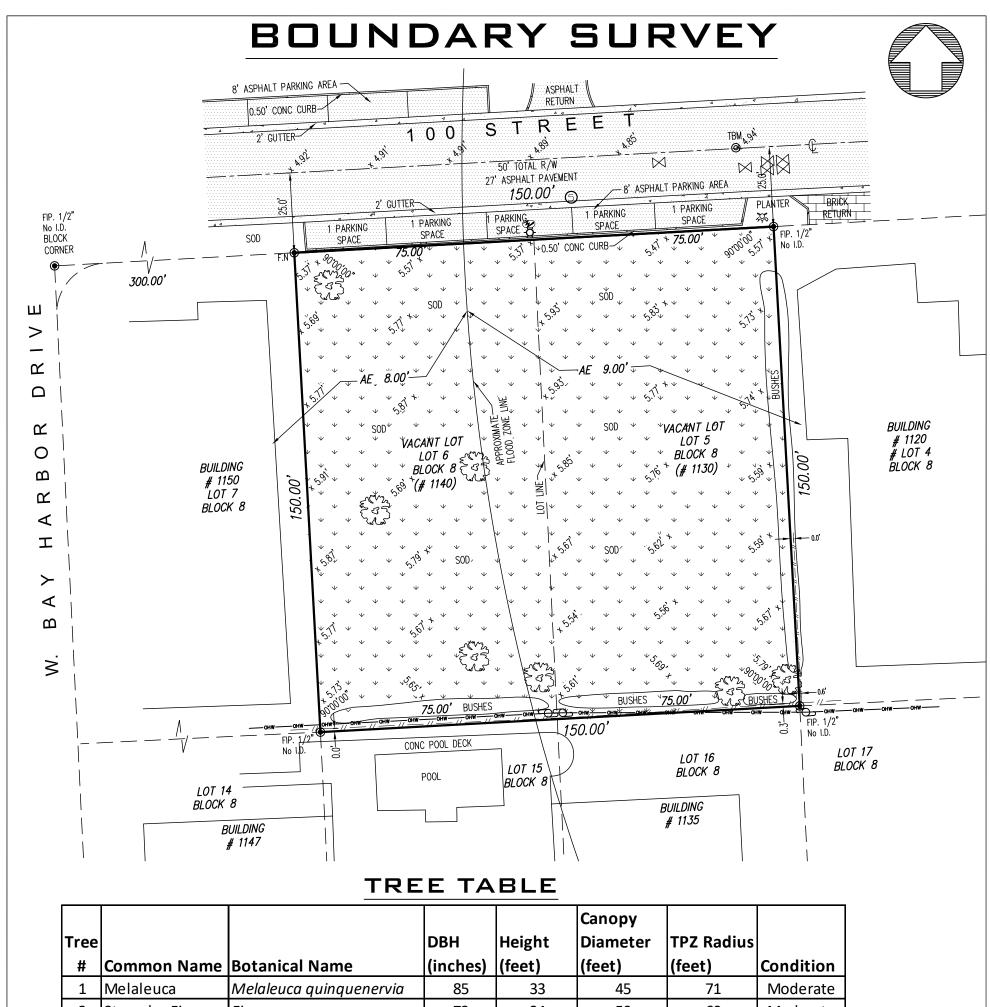

Tree			DBH	Heigh	t	Canopy Diameter	TPZ Radius	
#	Common Name	Botanical Name	(inches)	(feet)		(feet)	(feet)	Condition
1	Melaleuca	Melaleuca quinquenervia	85	33		45	71	Moderate
2	Strangler Fig	Ficus aurea	72	34		50	60	Moderate
3	Strangler Fig	Ficus aurea	30	35	ı	35	25	Moderate
4	Melaleuca	Melaleuca quinquenervia	30	35	ı	35	25	Poor
5	Mango Tree	Mangifera indica	27	18	)	26	23	Moderate
6	Brazilian Pepper	Schinus terebinthifolia	15	20		18	13	Poor
7	Strangler Fig	Ficus aurea	5	22		10	4	Poor
8	Carrotwood	Cupaniopsis anacardiodes	10	24		18	8	Poor
	IS AND LEGEND:	GENERAL NOTES:			PRO	PERTY ADDRES	5:	



### ABBREVIA

C.B.S.

C # G V.G. Q M F.F.E.

Ø

В.М.

=DENOTES AIR CONDITIONING UNIT =DENOTES BLOCK CORNER =DENOTES BENCH MARK

=DENOTES CONCRETE BLOCK STUCCO

= DENOTES CURVE & GUTTER = DENOTES VALLEY GUTTER = DENOTES CENTERLINE = DENOTES MONUMENT LINE = DENOTES FINISH FLOOR ELEVATION = DENOTES FOUND IRON PIPE NOT IDENTIFIED - DENOTES ELECTRIC METER

=DENOTES ELECTRIC METER =DENOTES DRILL HOLE =DENOTES MEASURE

D.H (M) =DENOTES RECORD =DENOTES RIGHT-OF-WAY

(R) R/W U.E.

=DENOTES UTILITY EASEMENT

=DENOTES PLAT BOOK PG. =DENOTES PAGE

=DENOTES PERMANENT CONTROL POINT x 0.00° =DENOTES TREE

=DENOTES CONCRETE LIGHT POLE =DENOTES ELECTRIC BOX

=DENOTES EXISTING ELEVATION

=DENOTES CATCH BASIN

=DENOTES WATER METER =DENOTES WATER VALVE

=DENOTES FIRE HYDRANT =DENOTES WOOD FENCE

=DENOTES CHAIN LINK FENCE =DENOTES METAL FENCE

=DENOTES OVERHEAD\_LINE =DENOTES FOUND IRON PIPE (NO ID.) =DENOTES FOUND NAIL AND DISC

=DENOTES WOOD POWER POLE =DENOTES MANHOLE SANITARY

=DENOTES ASPHALT

=DENOTES BRICK

=DENOTES CONCRETE PAD

=DENOTES TILE

## **GENERAL NOTES:**

THIS SURVEY IS NOT TO BE USED FOR DESIGN OR CONSTRUCTION PURPOSES

TO BE MADE TO DETERMINE RECORDED INSTRUMENTS, IF ANY,

AFFECT THIS PROPERTY.
THE LANDS SHOWN HEREON WERE NOT ABSTRACTED FOR EASEMENT OR OTHER RECORDED

ENCLIMERANCES NOT SHOWN ON THE PLAT.
UNDERGROUND PORTIONS OF FOOTING, FOUNDATIONS OR OTHER

IMPROVEMENTS WERE NOT LOCATED.

ONLY VISIBLE AND ABOVE GROUND ENCROACHMENTS LOCATED.

WALL TIES ARE THE FACE OF THE WALL. FENCE OWNERSHIP NOT DETERMINED.
BEARINGS REFERENCED TO LINE NOTED AS B.R.

BOUNDARY SURVEY MEANS A DRAWING AND/OR GRAPHIC REPRESENTATION OF THE SURVEY WORK PERFORMED IN THE FIELD, COULD BE DRAWN AT A SHOWN SCALE AND/OR NOT

IO SCALE.

NO IDENTIFICATION FOUND ON PROPERTY CORNERS UNLESS NOTED.

NOT VALID UNLESS SEALED WITH THE SIGNINGS SURVEYORS EMBOSSED SEAL.

DIMENSIONS SHOWN ARE PLAT AND MEASURED UNLESS OTHERWISE SHOWN.

ELEVATIONS IF SHOWN ARE BASED UPON N.G.V.D. 29 UNLESS OTHERWISE

NOTED. THIS IS A BOUNDARY SURVEY UNLESS OTHERWISE NOTED. THIS BOUNDARY SURVEY HAS BEEN PREPARED FOR THE EXCLUSIVE USE OF THE ENTITIES NAME HEREON. THE CERTIFICATIONS DO NOT EXTEND TO ANY

**BOUNDARY SURVEY** 

DATE	DRAWN BY	SCALE	
09-09-2022	I.C.	1"=30'	1

## REVISION / UPDATE OF SURVEY

DATE	DESCRIPTION
11/16/2022	ADD TREE # ELEVATIONS

## 1130-1140 100th STREET, BAY LEGAL DESCRIPTION:

LOT 5 AND LOT 6, BLOCK 8, OF " BAY HARBOR ISLAND " ACCORDING TO THE PLAT THEREOF, AS RECORDED IN PLAT BOOK 46, AT PAGE 5, OF THE PUBLIC RECORDS OF MIAMI-DADE COUNTY, FLORIDA.

HARBOR ISLANDS, FLORIDA, 33154

## CERTIFIED TO:

JOB NUMBER: 220905 - LEE COHEN ALL BEARINGS AND DISTANCES SHOWN HEREON ARE RECORD AND MEASURED UNLESS OTHERWISE NOTED.

FIELD DATE OF SURVEY	09-09-2022 FLOOD ZON		COMMUNITY:	PANEL:
	D 0.40	AE	120637	0144
BENCH MARK:	R-243	ELEVATION:	DATE OF FIRM:	SUFFIX:
ELEVATION:	6.61'	80'90'	09-11-2009	L

#### ALPHA C&N LAND SERVICES, LLC BUSINESS LICENSE LB# 8426

5801 N.W. 2ND STREET, MIAMI, FL 33126 PH: (305) 588-6779 (305) 336-II23 ALPHACNLANDSERVICES@GMAIL.COM

PEDRO LUIS MARTINEZ . LS No 5443-STATE OF FLORIDA NOT VALID WITHOUT AN AUTHENTIC ELECTRONIC SIGNATURE AND AUTHENTICATED ELECTRONIC SEAL AND/OR THIS MAP IS NOT VALID WITHOUT THE SIGNATURE AND THE ORIGINAL RAISED SEAL OF A LICENSE SURVEYOR AND MAPPER.



EXTERIOR RENDERING

BHI 1130-1140 100TH ST

1130-1140 100TH STREET, BAY HARBOR ISLANDS, FL 33154

DEVELOPER: Redhoek + Partners

138 PIONEER STREET BROOKLYN, NY 11231 T: 718.852.8162

DESIGNER: FAB 314 ARCHITECTURE WORKSHOP HAYESOD STREET 2 #121 TEL AVIV-YAFO, 6816721, IL T: 972-50-888-2629

DESIGNER: PLISKIN ARCHITECTURE PLLC 233 BROADWAY, SUITE 2030

NEW YORK, NY 10279 T: 212-899-9885

ARCHITECT: CARL LEVIN ARCHITECTURE + DESIGN
3390 MARY STREET, SUITE 135
COCONUT GROVE, FL 33133

NGA ENGINEERS INC. 11231 SW 88TH ST., UNIT D-114 MIAMI, FL 33176 T: 305 200 6701

T: 305 442 3118


LANDSCAPE: STRATA LANDSCAPE ARCHITECTURE 1906 TIGERTAIL AVE MIAMI, FL 33133 T: 305 747 9336

LIGHTING: POWER & LIGHTING SYSTEMS, INC. 3832 SHIPPING AVE. MIAMI, FL 33146 T: 305 444 8520

DOB APPROVAL STAMP

DOB APPROVAL SCAN

. 01 ISSUE FOR SITE PLAN REVIEW . 12. 29. 2022

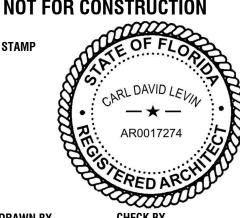

**PROJECT NUMBER** 2218

EXTERIOR RENDERING

DRAWING NO.





BHI 1130-1140 100TH ST

1130-1140 100TH STREET, BAY HARBOR ISLANDS, FL 33154

DEVELOPER: Redhoek + Partners

138 PIONEER STREET BROOKLYN, NY 11231 T: 718.852.8162

DESIGNER: FAB 314 ARCHITECTURE WORKSHOP HAYESOD STREET 2 #121 TEL AVIV-YAFO, 6816721, IL T: 972-50-888-2629

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NEW YORK, NY 10279 T: 212-899-9885

ARCHITECT:
CARL LEVIN ARCHITECTURE + DESIGN
3390 MARY STREET, SUITE 135
COCONUT GROVE, FL 33133
T: 305 442 3118

CIVIL: Nga engineers inc. 11231 SW 88TH ST., UNIT D-114 MIAMI, FL 33176 T: 305 200 6701


LANDSCAPE: STRATA LANDSCAPE ARCHITECTURE 1906 TIGERTAIL AVE MIAMI, FL 33133 T: 305 747 9336

LIGHTING:
POWER & LIGHTING SYSTEMS, INC.
3832 SHIPPING AVE.
MIAMI, FL 33146
T: 305 444 8520

DOB APPROVAL STAMP

DOB APPROVAL SCAN

• 01 ISSUE FOR SITE PLAN REVIEW • 12, 29, 2022

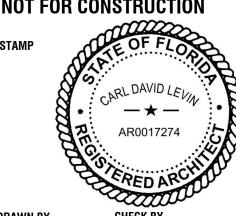

**PROJECT NUMBER** 2218

TITLE EXTERIOR RENDERING





**BHI 1130-1140 100TH ST** 1130-1140 100TH STREET, BAY HARBOR ISLANDS, FL 33154

DEVELOPER:
REDHOEK + PARTNERS
138 PIONEER STREET
BROOKLYN, NY 11231
T: 718.852.8162

DESIGNER: FAB 314 ARCHITECTURE WORKSHOP HAYESOD STREET 2 #121 TEL AVIV-YAFO, 6816721, IL T: 972-50-888-2629

DESIGNER:
PLISKIN ARCHITECTURE PLLC
233 BROADWAY, SUITE 2030
NEW YORK, NY 10279
T: 212-899-9885


ARCHITECT:
CARL LEVIN ARCHITECTURE + DESIGN
3390 MARY STREET, SUITE 135
COCONUT GROVE, FL 33133
T: 305 442 3118

CIVIL:
NGA ENGINEERS INC.
11231 SW 88TH ST., UNIT D-114
MIAMI, FL 33176
T: 305 200 6701


# LANDSCAPE: STRATA LANDSCAPE ARCHITECTURE 1906 TIGERTAIL AVE MIAMI, FL 33133 T: 305 747 9336

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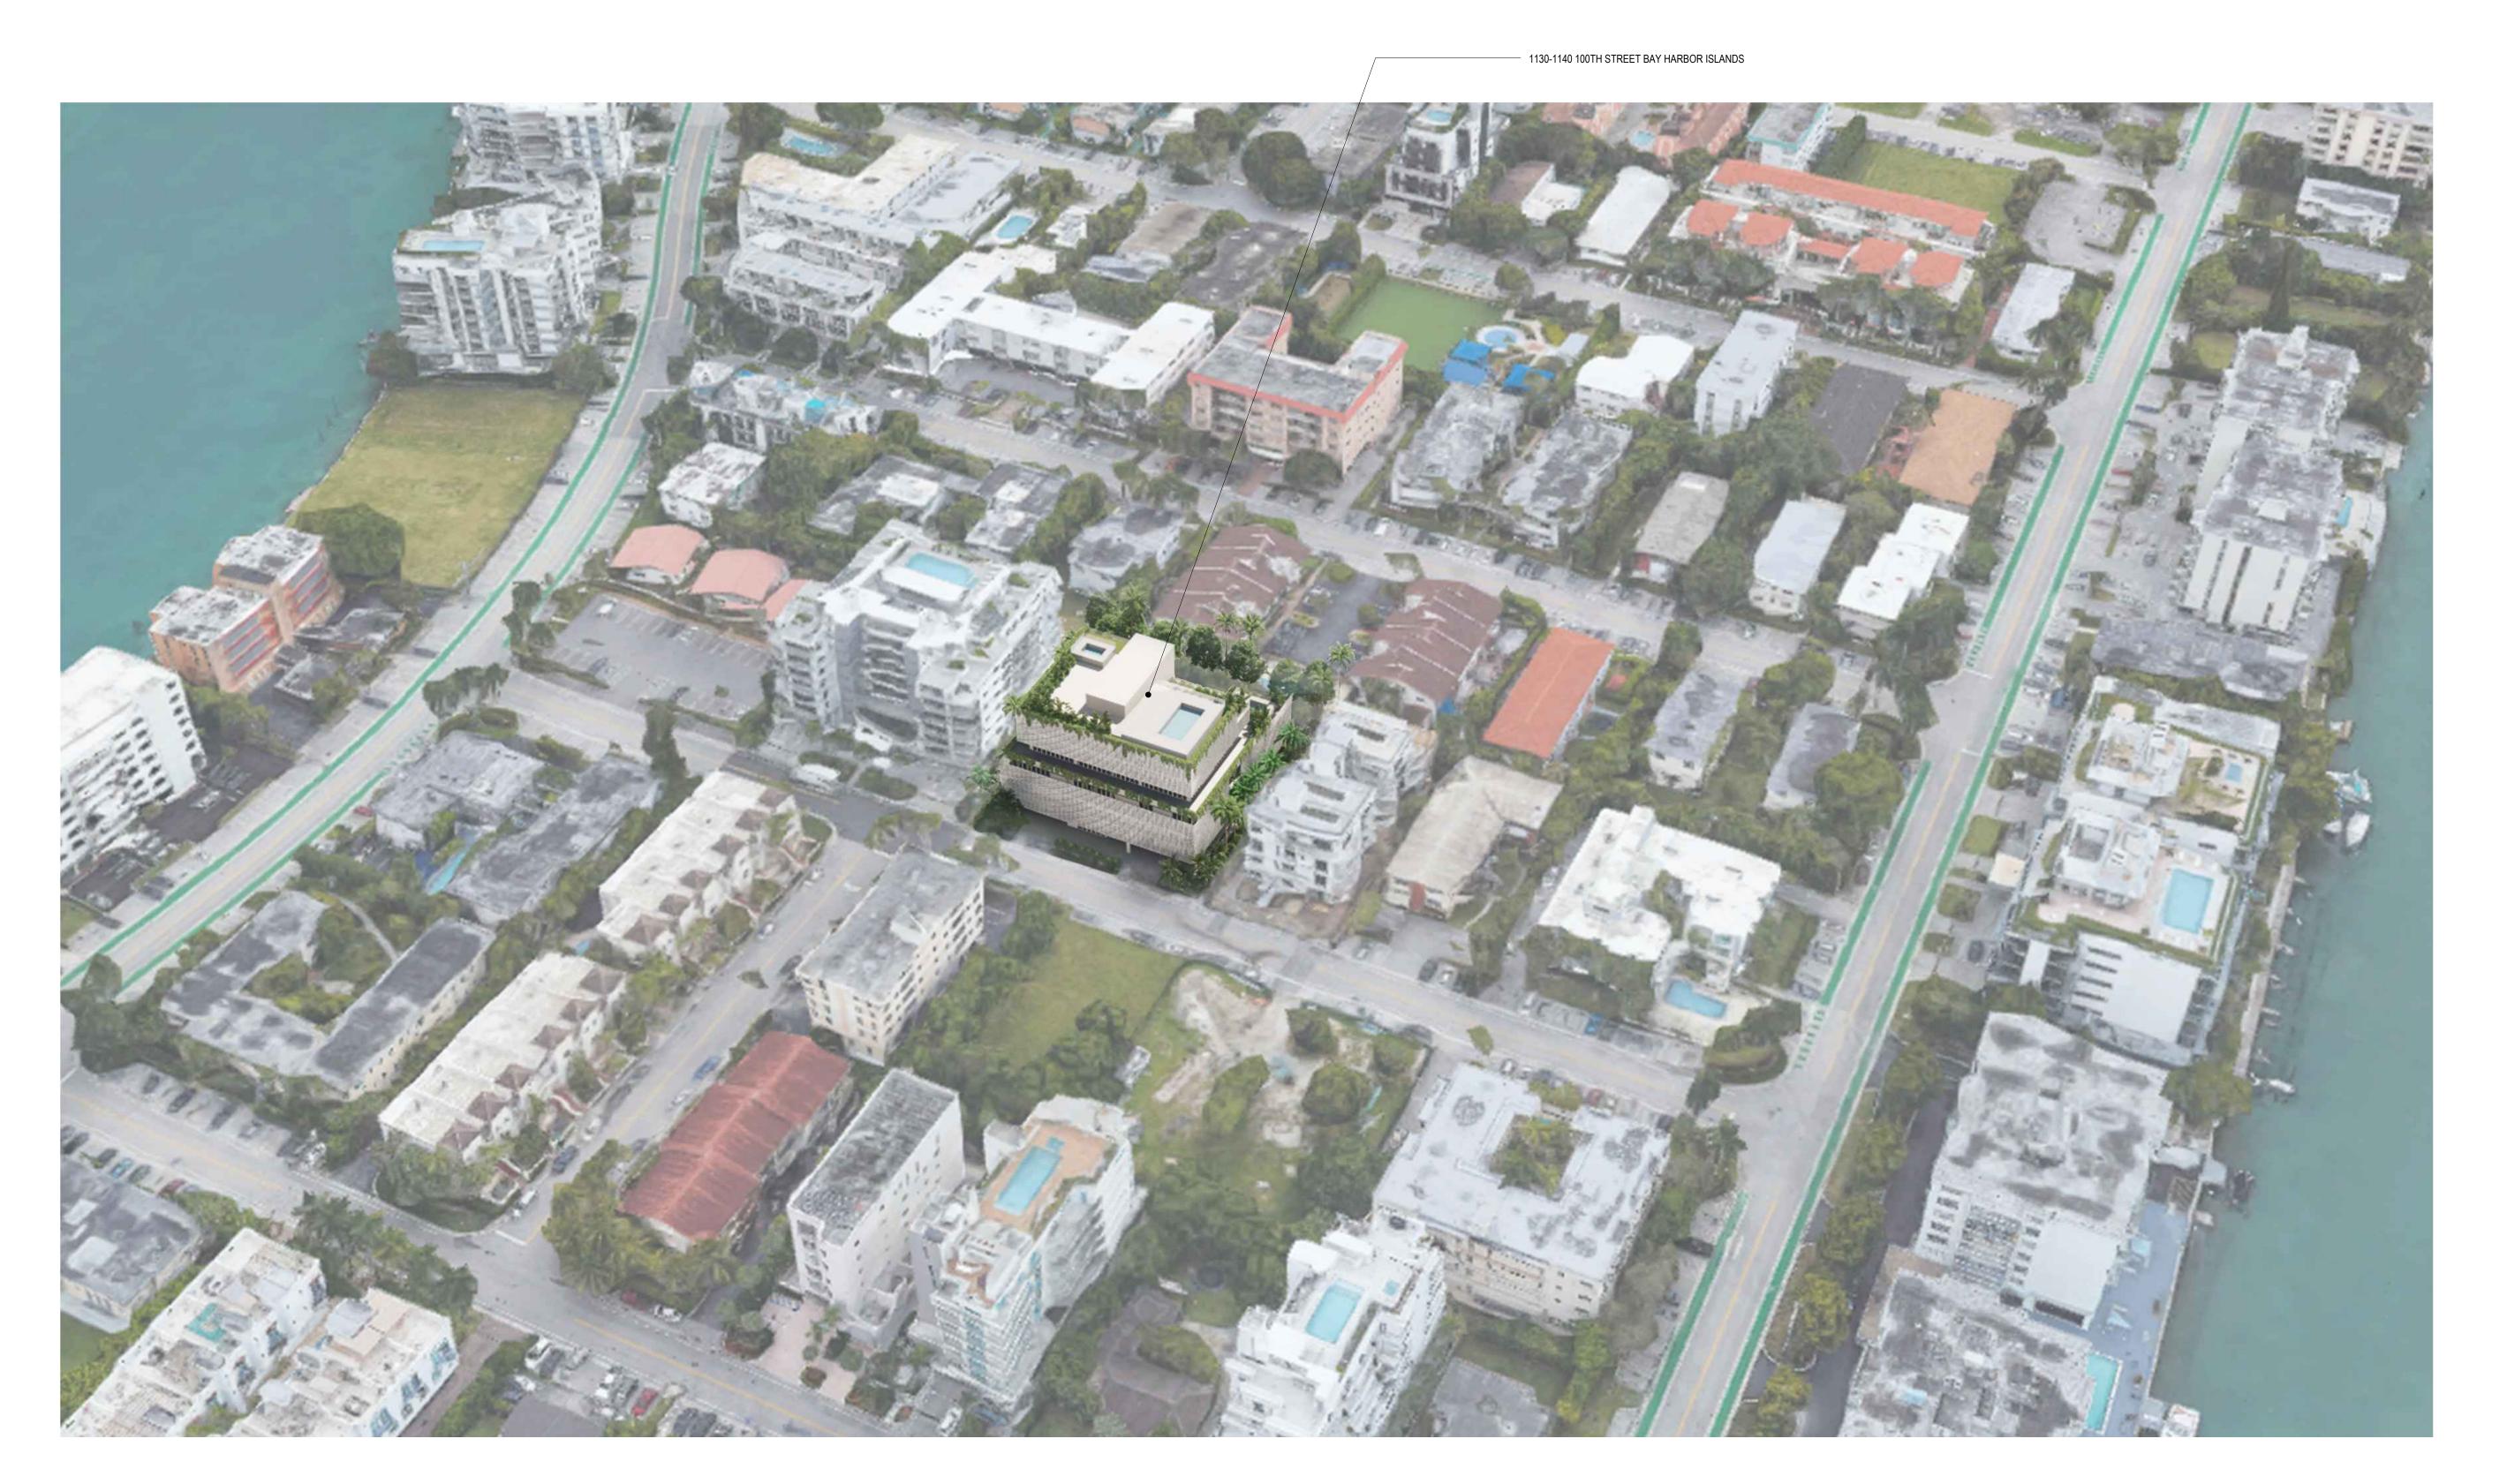
DOB APPROVAL STAMP

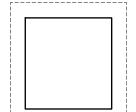

. 01 ISSUE FOR SITE PLAN REVIEW . 12, 29, 2022

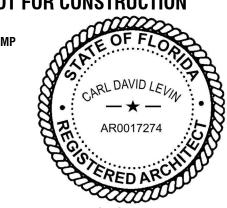

EXTERIOR RENDERING



AERIAL RENDERING

SCALE: 1/8" =1' - 0"

## BHI 1130-1140 100TH ST

1130-1140 100TH STREET, BAY HARBOR ISLANDS, FL 33154

DEVELOPER: REDHOEK + PARTNERS 138 PIONEER STREET BROOKLYN, NY 11231 T: 718.852.8162

DESIGNER: FAB 314 ARCHITECTURE WORKSHOP HAYESOD STREET 2 #121 TEL AVIV-YAFO, 6816721, IL T: 972-50-888-2629

DESIGNER:
PLISKIN ARCHITECTURE PLLC
233 BROADWAY, SUITE 2030
NEW YORK, NY 10279
T: 212-899-9885

ARCHITECT:
CARL LEVIN ARCHITECTURE + DESIGN
3390 MARY STREET, SUITE 135
COCONUT GROVE, FL 33133
T: 305 442 3118


CIVIL:
NGA ENGINEERS INC.
11231 SW 88TH ST., UNIT D-114
MIAMI, FL 33176
T: 305 200 6701

# LANDSCAPE: STRATA LANDSCAPE ARCHITECTURE 1906 TIGERTAIL AVE MIAMI, FL 33133 T: 305 747 9336


# LIGHTING: POWER & LIGHTING SYSTEMS, INC. 3832 SHIPPING AVE. MIAMI, FL 33146 T: 305 444 8520

DOB APPROVAL STAMP

DOB APPROVAL SCAN

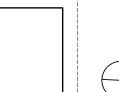

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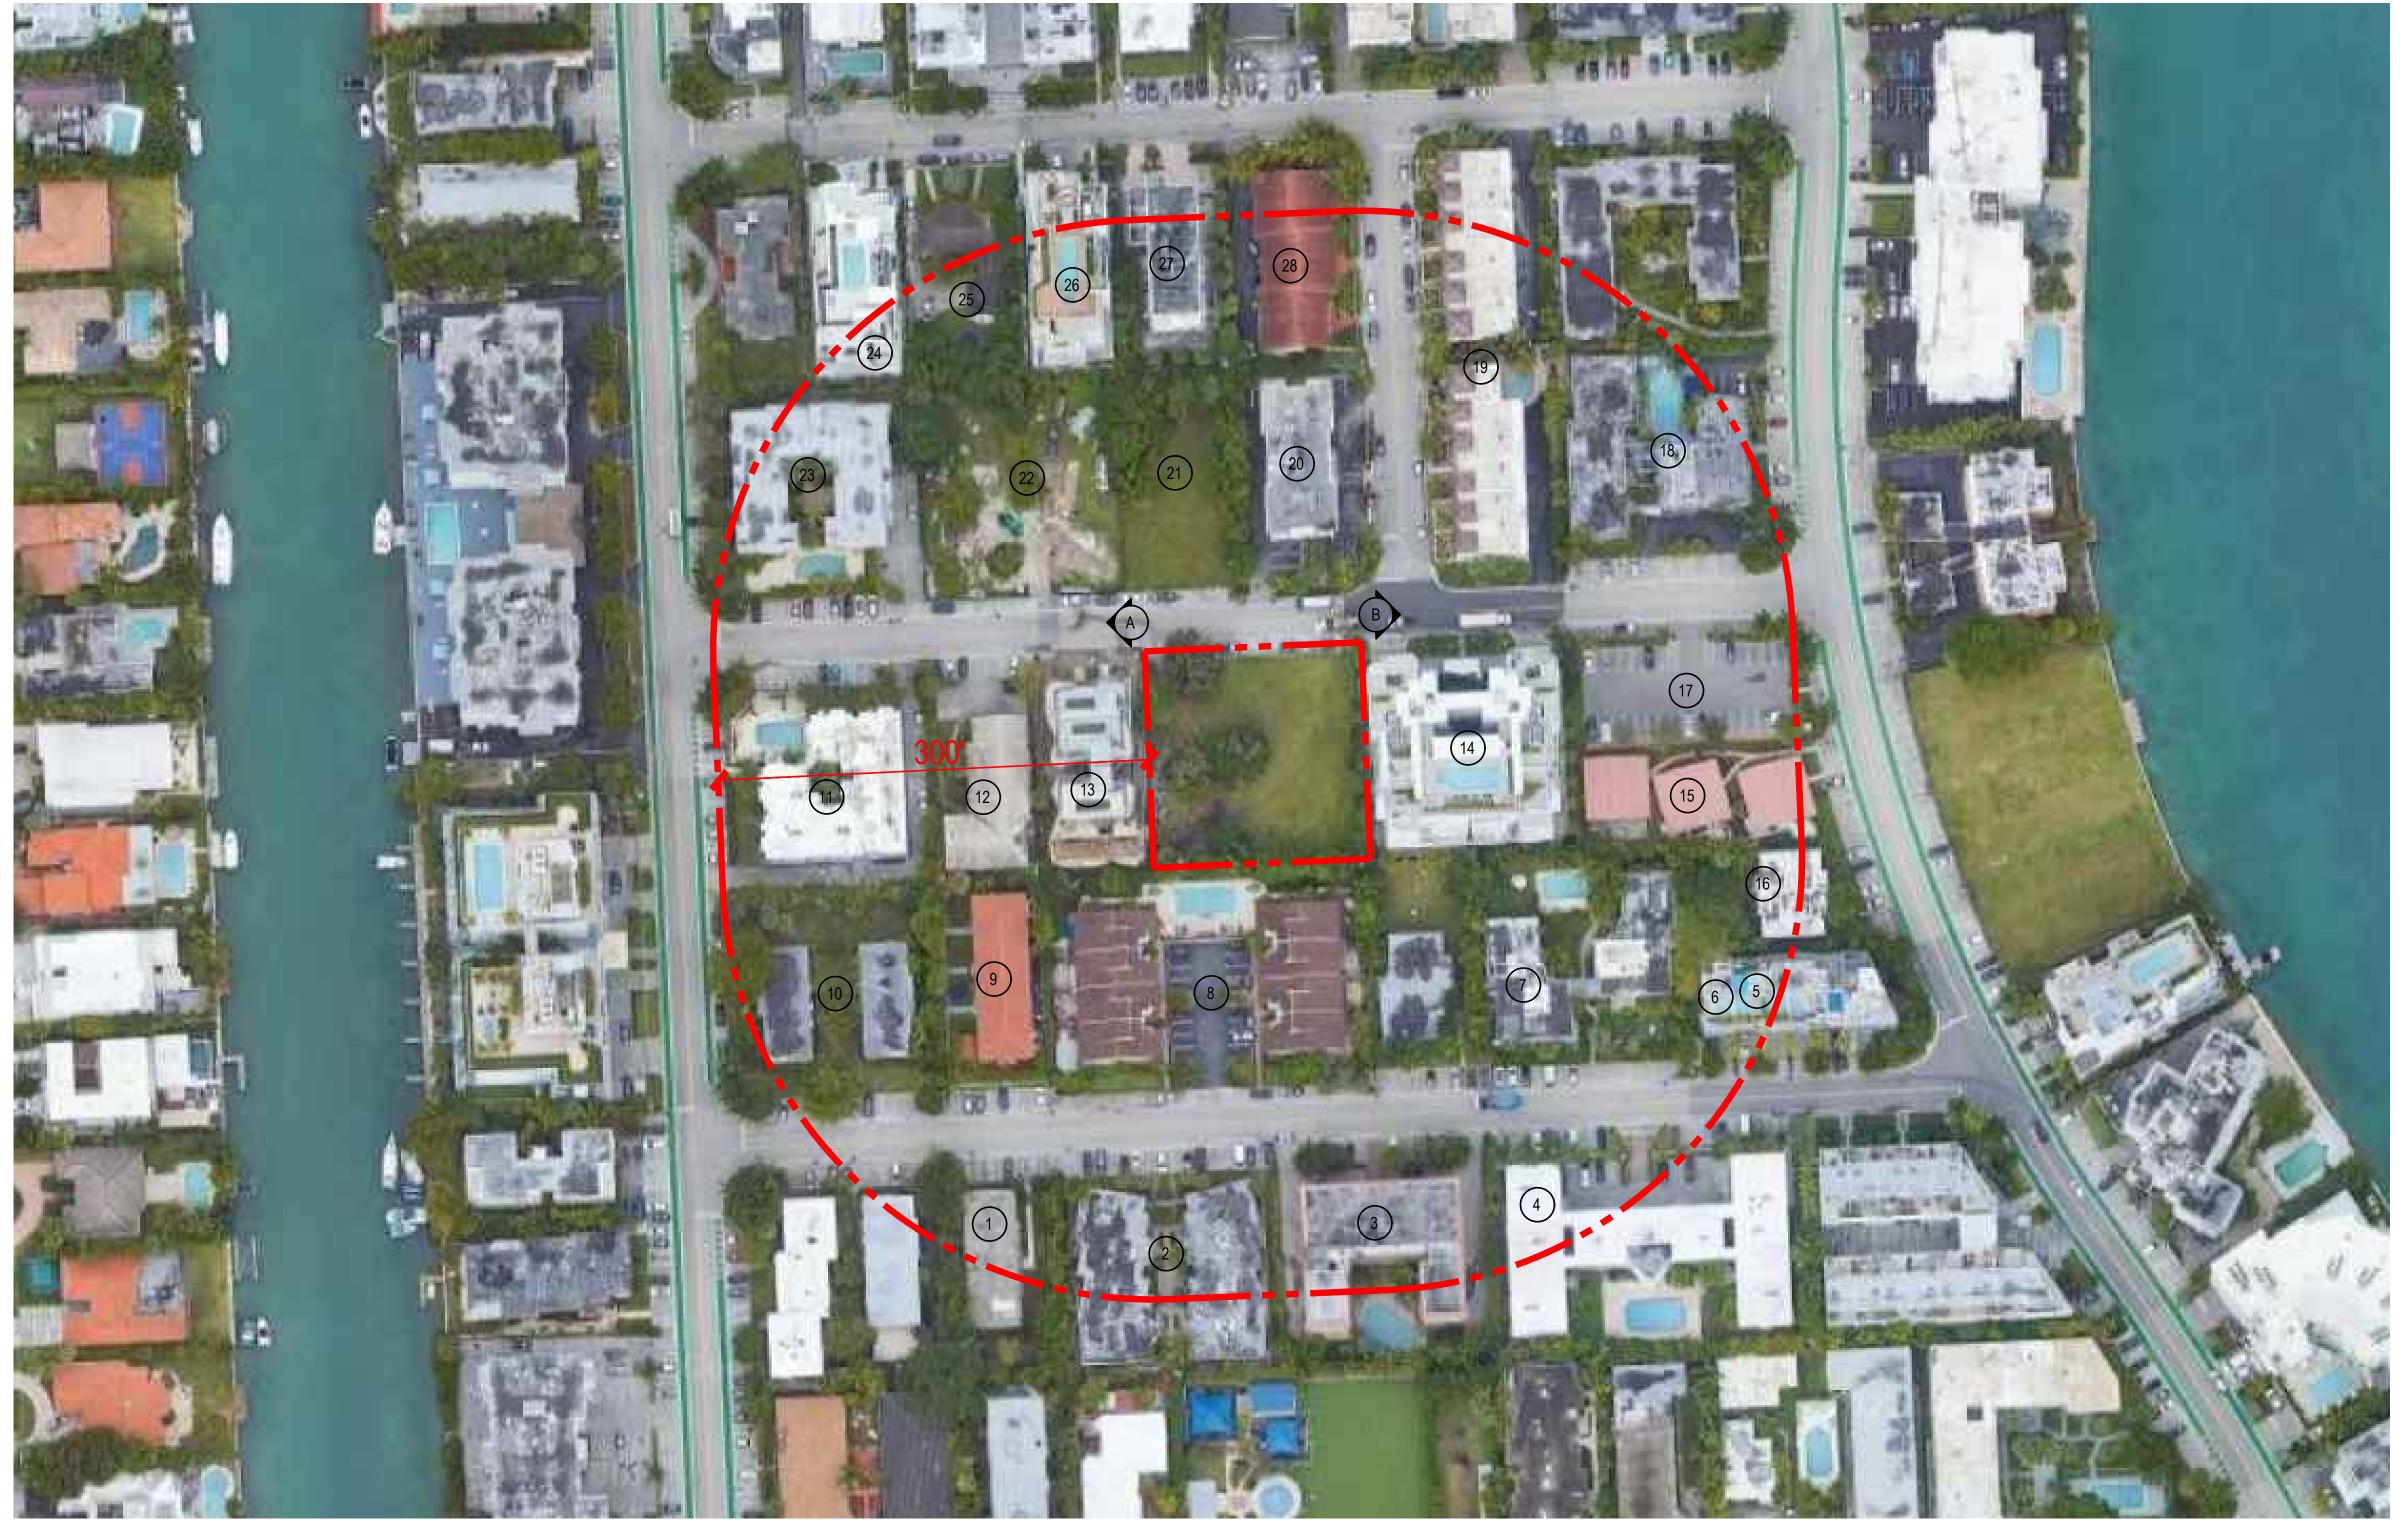


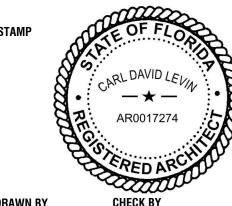
**PROJECT NUMBER** 2218

AERIAL RENDERING

# ADJACENT LAND USES

ADDRESS	STORIES	LAND USES (DWELLING UNIT
1. 1160 99TH STREET 2. 1140 99TH STREET 3. 1120 99TH STREET 4. 1080 99TH STREET 5. 1075 99TH STREET	2 2 5 3 3	RESIDENTIAL (4 D.U.) RESIDENTIAL (16 D.U.) RESIDENTIAL (25 D.U.) RESIDENTIAL (23 D.U.) RESIDENTIAL (1 D.U.)
6. 1065 99TH STREET 7. 1085 99TH STREET 8. 1135 99TH STREET 9. 1165 99TH STREET 10. 1175 99TH STREET	3 2 2 2	RESIDENTIAL (1 D.U.) RESIDENTIAL (4 D.U.) RESIDENTIAL (8 D.U.) RESIDENTIAL (7 D.U.) UNDER CONSTRUCTION
11. 9917 W BAY HARBOR DR 12. 1160 100TH STREET 13. 1150 100TH STREET 14. 1120 100TH STREET 15. 9970-9980 E BAY HARBOR DR	3 2 4 8 1	RESIDENTIAL (11 D.U.) RESIDENTIAL (6 D.U.) UNDER CONSTRUCTION RESIDENTIAL (36 D.U.) RESIDENTIAL (3 D.U.)
16. 9950 E BAY H ARBOR DR 17. 9665 BAY HARBOR TERR 18. 10002 E BAY HARBOR DR 19. 10011-10093 BAY HARBOR TERR 20. 10000 BAY HARBOR TERR	2 2 3 5	RESIDENTIAL (4 D.U.) VACANT RESIDENTIAL (18 D.U.) RESIDENTIAL (12 D.U.) RESIDENTIAL (12 D.U.)
21. 1145 100TH STREET 22. 1155-1167 100TH STREET 23. 10001 W BAY HARBOR DR 24. 1170 101ST STREET 25. 1160-1164 101ST STREET	4 7 1	UNDER CONSTRUCTION UNDER CONSTRUCTION RESIDENTIAL (33 D.U.) RESIDENTIAL (15 D.U.) RESIDENTIAL (2 D.U.)
26. 1150 101ST STREET 27. 1140 101ST STREET 28. 10090-10010 BAY HARBOR TERR	7 6 2	RESIDENTIAL (17 D.U.) RESIDENTIAL (10 D.U.) RESIDENTIAL (6 D.U.)



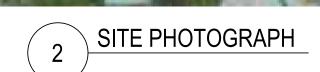



A. WEST STREET VIEW



B. EAST STREET VIEW



13. 1150 100TH STREET



14. 1120 100TH STREET





21. 1145 100TH STREET CONTEXT PHOTOGRAPHS

## BHI 1130-1140 100TH ST

1130-1140 100TH STREET, BAY HARBOR ISLANDS, FL 33154

## DEVELOPER: Redhoek + Partners

138 PIONEER STREET BROOKLYN, NY 11231 T: 718.852.8162

DESIGNER: FAB 314 ARCHITECTURE WORKSHOP HAYESOD STREET 2 #121 TEL AVIV-YAFO, 6816721, IL T: 972-50-888-2629

# DESIGNER: PLISKIN ARCHITECTURE PLLC 233 BROADWAY, SUITE 2030 NEW YORK, NY 10279 T: 212-899-9885

# ARCHITECT: CARL LEVIN ARCHITECTURE + DESIGN 3390 MARY STREET, SUITE 135 COCONUT GROVE, FL 33133 T: 305 442 3118

CIVIL: Nga engineers inc.

11231 SW 88TH ST., UNIT D-114 MIAMI, FL 33176 T: 305 200 6701

# LANDSCAPE: STRATA LANDSCAPE ARCHITECTURE 1906 TIGERTAIL AVE MIAMI, FL 33133 T: 305 747 9336


# LIGHTING: POWER & LIGHTING SYSTEMS, INC. 3832 SHIPPING AVE. MIAMI, FL 33146 T: 305 444 8520

DOB APPROVAL STAMP

DOB APPROVAL SCAN




• 01 ISSUE FOR SITE PLAN REVIEW • 12, 29, 2022

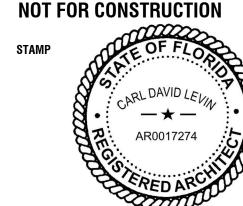


**PROJECT NUMBER** 2218

SITE AND CONTEXT PHOTOGRAPHS

DRAWING NO.

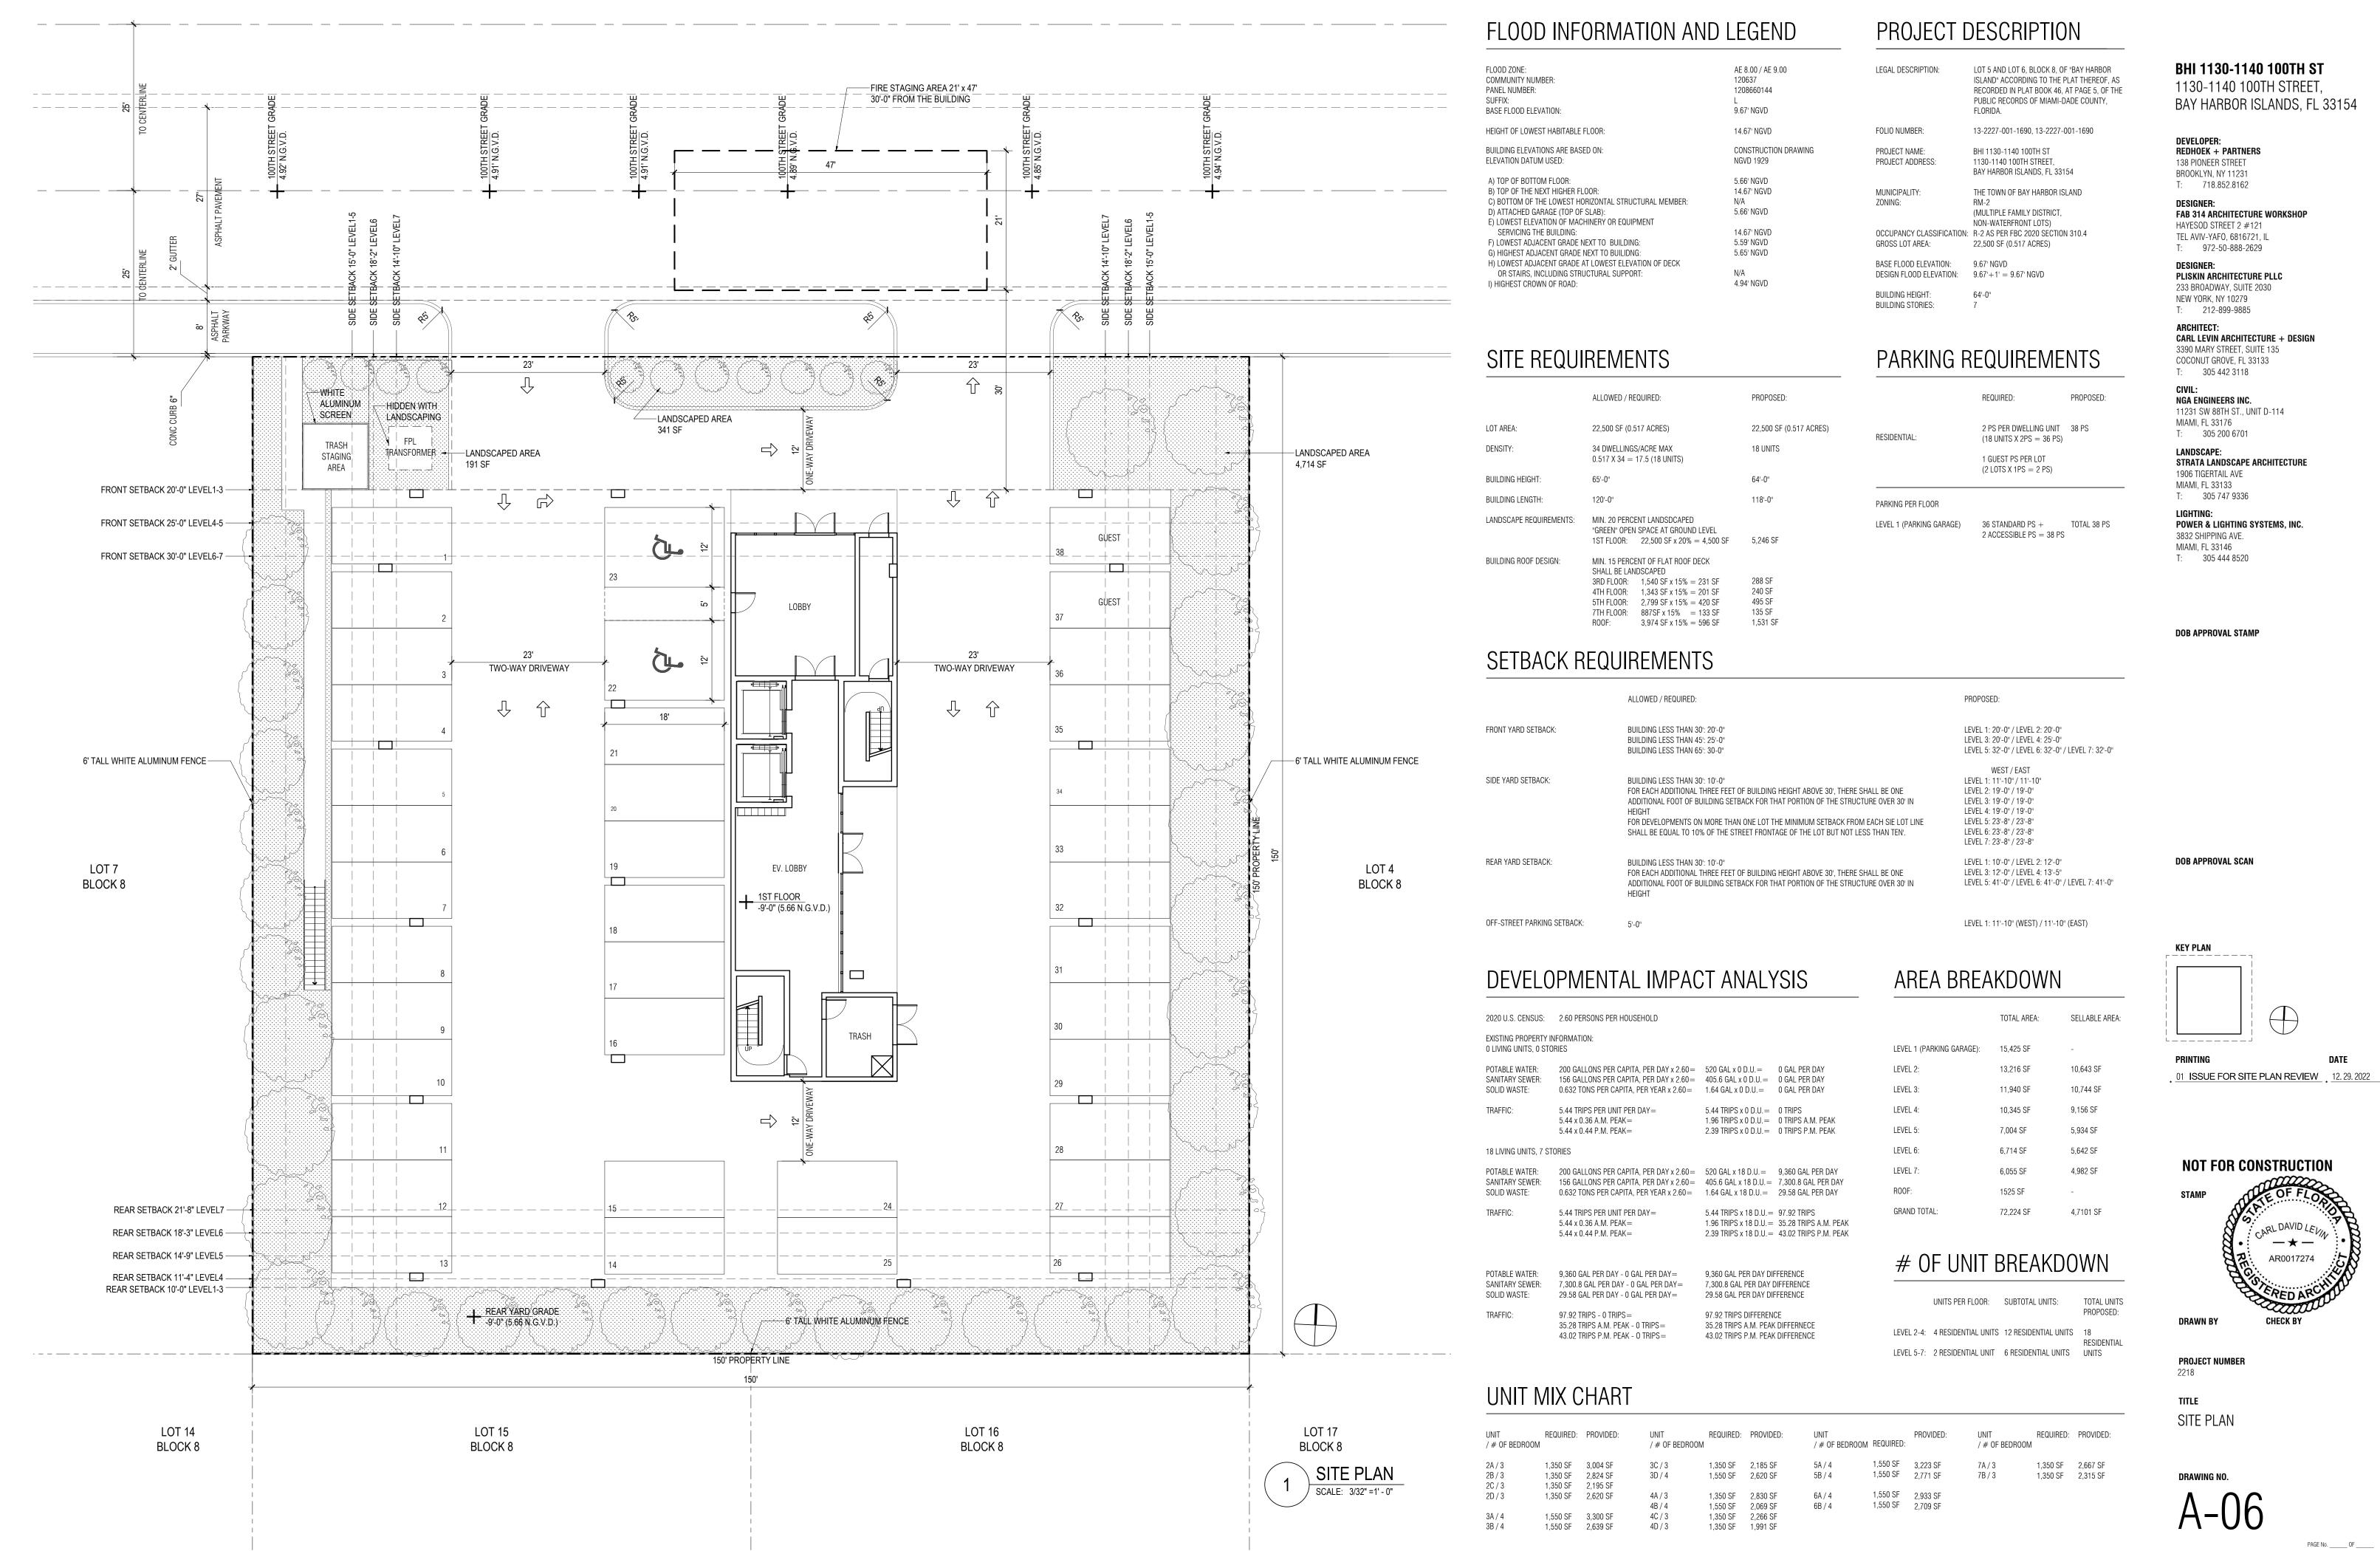

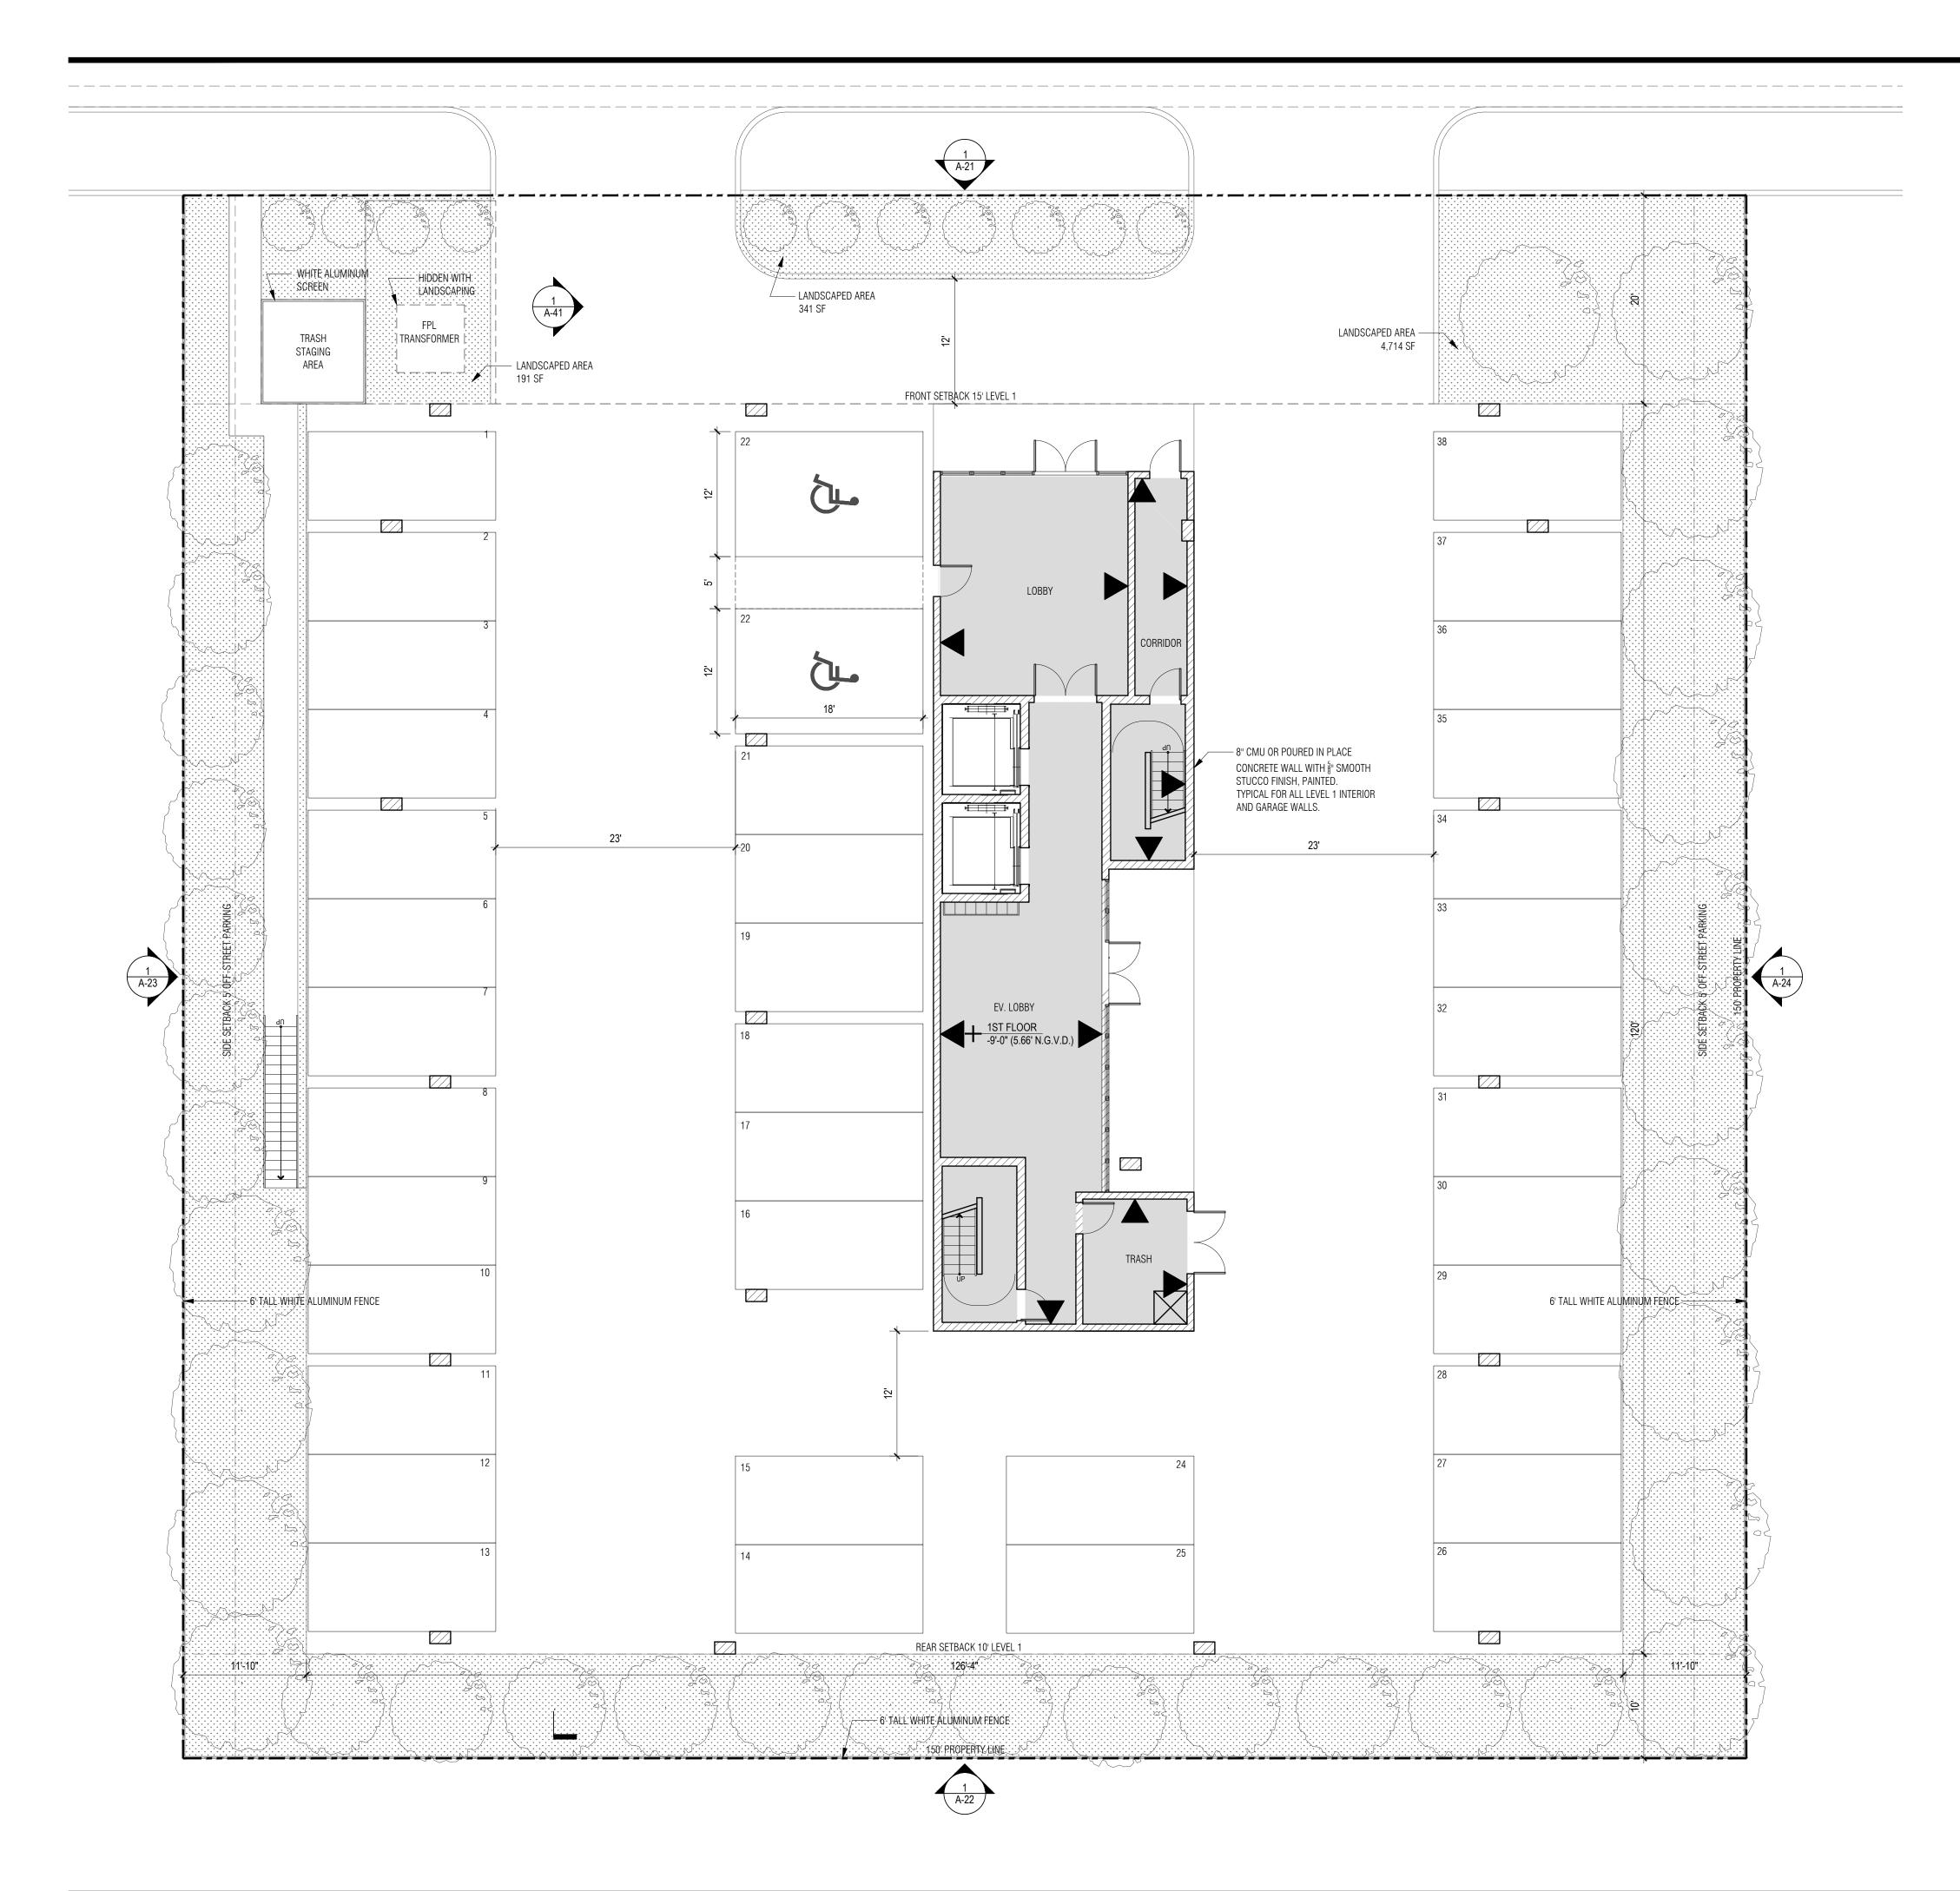

## DRAWING KEY

8" CMU OR POURED IN PLACE CONCRETE WALL WITH \$" SMOOTH STUCCO FINISH, PAINTED

WET-FLOOD AREA

ENGINEERED FLOOD VENT (SMART VENT MO. NO. 1540-520)

# SHEET NOTES

1. ALL MATERIALS BELOW BFE +1 ( 9.00' N.G.V.D.) TO BE COMPATIBLE WITH FLOOD-RESISTANT MATERIALS IN ACCORDANCE WITH SECTION 5, ASCE 24.

2. PROPOSED LAYOUT DESIGNED TO RPOVIDE FOR THE AUTOMATIC ENTRY AND EXIT OF FLOODWATERS FOR EQUALIZATION OF HYDROSTATIC FLOOD FORCES IN ACCORDANCE WITH SECTON 2.6.2, ASCE 24.

3. ALL FLOOD VENTS TO COMPLY WITH THE DESIGN PRINCIPLE NOTED IN SECTION 2.7.2.2 AND SECTION 2.7.3 OF ASCE/SEI 24-14 FOR A MAXIMUM RATE OF RISE AND FALL OF 5.0 FEET PER HOUR (0.423 MM/S).

# FLOOD VENT CALCULATION

FLOOD VENT SIZE = 16" W x 8" H X 3"D FLOOD VENT OPENING SIZE = 16.25" W X 8.25" H FLOOD VENT COVERAGE = 200 SF

WET FLOODED AREA 1: LOBBY = 381 SF 2 X FLOOD VENT = 2 X 200 SF = 400 SF FLOOD COVERAGE = 400 SF > WET FLOODED AREA 381 SF

WET FLOODED AREA 2: CORRIDOR = 103 SF 2 X FLOOD VENT = 2 X 200 SF = 400 SF FLOOD COVERAGE = 400 SF > WET FLOODED AREA 103 SF

WET FLOODED AREA 3: ELEVATOR LOBBY = 599 SF 2 X FLOOD VENT = 3 X 200 SF = 600 SF FLOOD COVERAGE = 600 SF > WET FLOODED AREA 599 SF

WET FLOODED AREA 4: STAIRCASE 1 = 108 SF 2 X FLOOD VENT = 2 X 200 SF = 400 SF FLOOD COVERAGE = 400 SF > WET FLOODED AREA 108 SF

WET FLOODED AREA 5: STAIRCASE 2 = 108 SF 2 X FLOOD VENT = 2 X 200 SF = 400 SF FLOOD COVERAGE = 400 SF > WET FLOODED AREA 108 SF

WET FLOODED AREA 6: TRASHROOM = 120 SF 2 X FLOOD VENT = 2 X 200 SF = 400 SF FLOOD COVERAGE = 400 SF > WET FLOODED AREA 120 SF

## BHI 1130-1140 100TH ST

1130-1140 100TH STREET, BAY HARBOR ISLANDS, FL 33154

# DEVELOPER: REDHOEK + PARTNERS

138 PIONEER STREET BROOKLYN, NY 11231 T: 718.852.8162

#### DESIGNER: **FAB 314 ARCHITECTURE WORKSHOP** HAYESOD STREET 2 #121

TEL AVIV-YAFO, 6816721, IL

## T: 972-50-888-2629 DESIGNER: PLISKIN ARCHITECTURE PLLC

233 BROADWAY, SUITE 2030 NEW YORK, NY 10279

# T: 212-899-9885

ARCHITECT: CARL LEVIN ARCHITECTURE + DESIGN 3390 MARY STREET, SUITE 135 COCONUT GROVE, FL 33133

## T: 305 442 3118 NGA ENGINEERS INC.

11231 SW 88TH ST., UNIT D-114 MIAMI, FL 33176 T: 305 200 6701


#### LANDSCAPE: STRATA LANDSCAPE ARCHITECTURE 1906 TIGERTAIL AVE

MIAMI, FL 33133 T: 305 747 9336

#### LIGHTING: POWER & LIGHTING SYSTEMS, INC. 3832 SHIPPING AVE. MIAMI, FL 33146 T: 305 444 8520


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**PROJECT NUMBER** 2218

TITLE

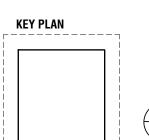
1ST FLOOR FLOOR PLAN

DRAWING NO.

1ST FLOOR PLAN

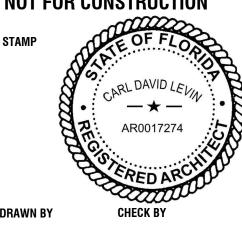SCALE: 1/8" =1' - 0"

PAGE No. \_\_\_\_\_ OF \_\_\_\_

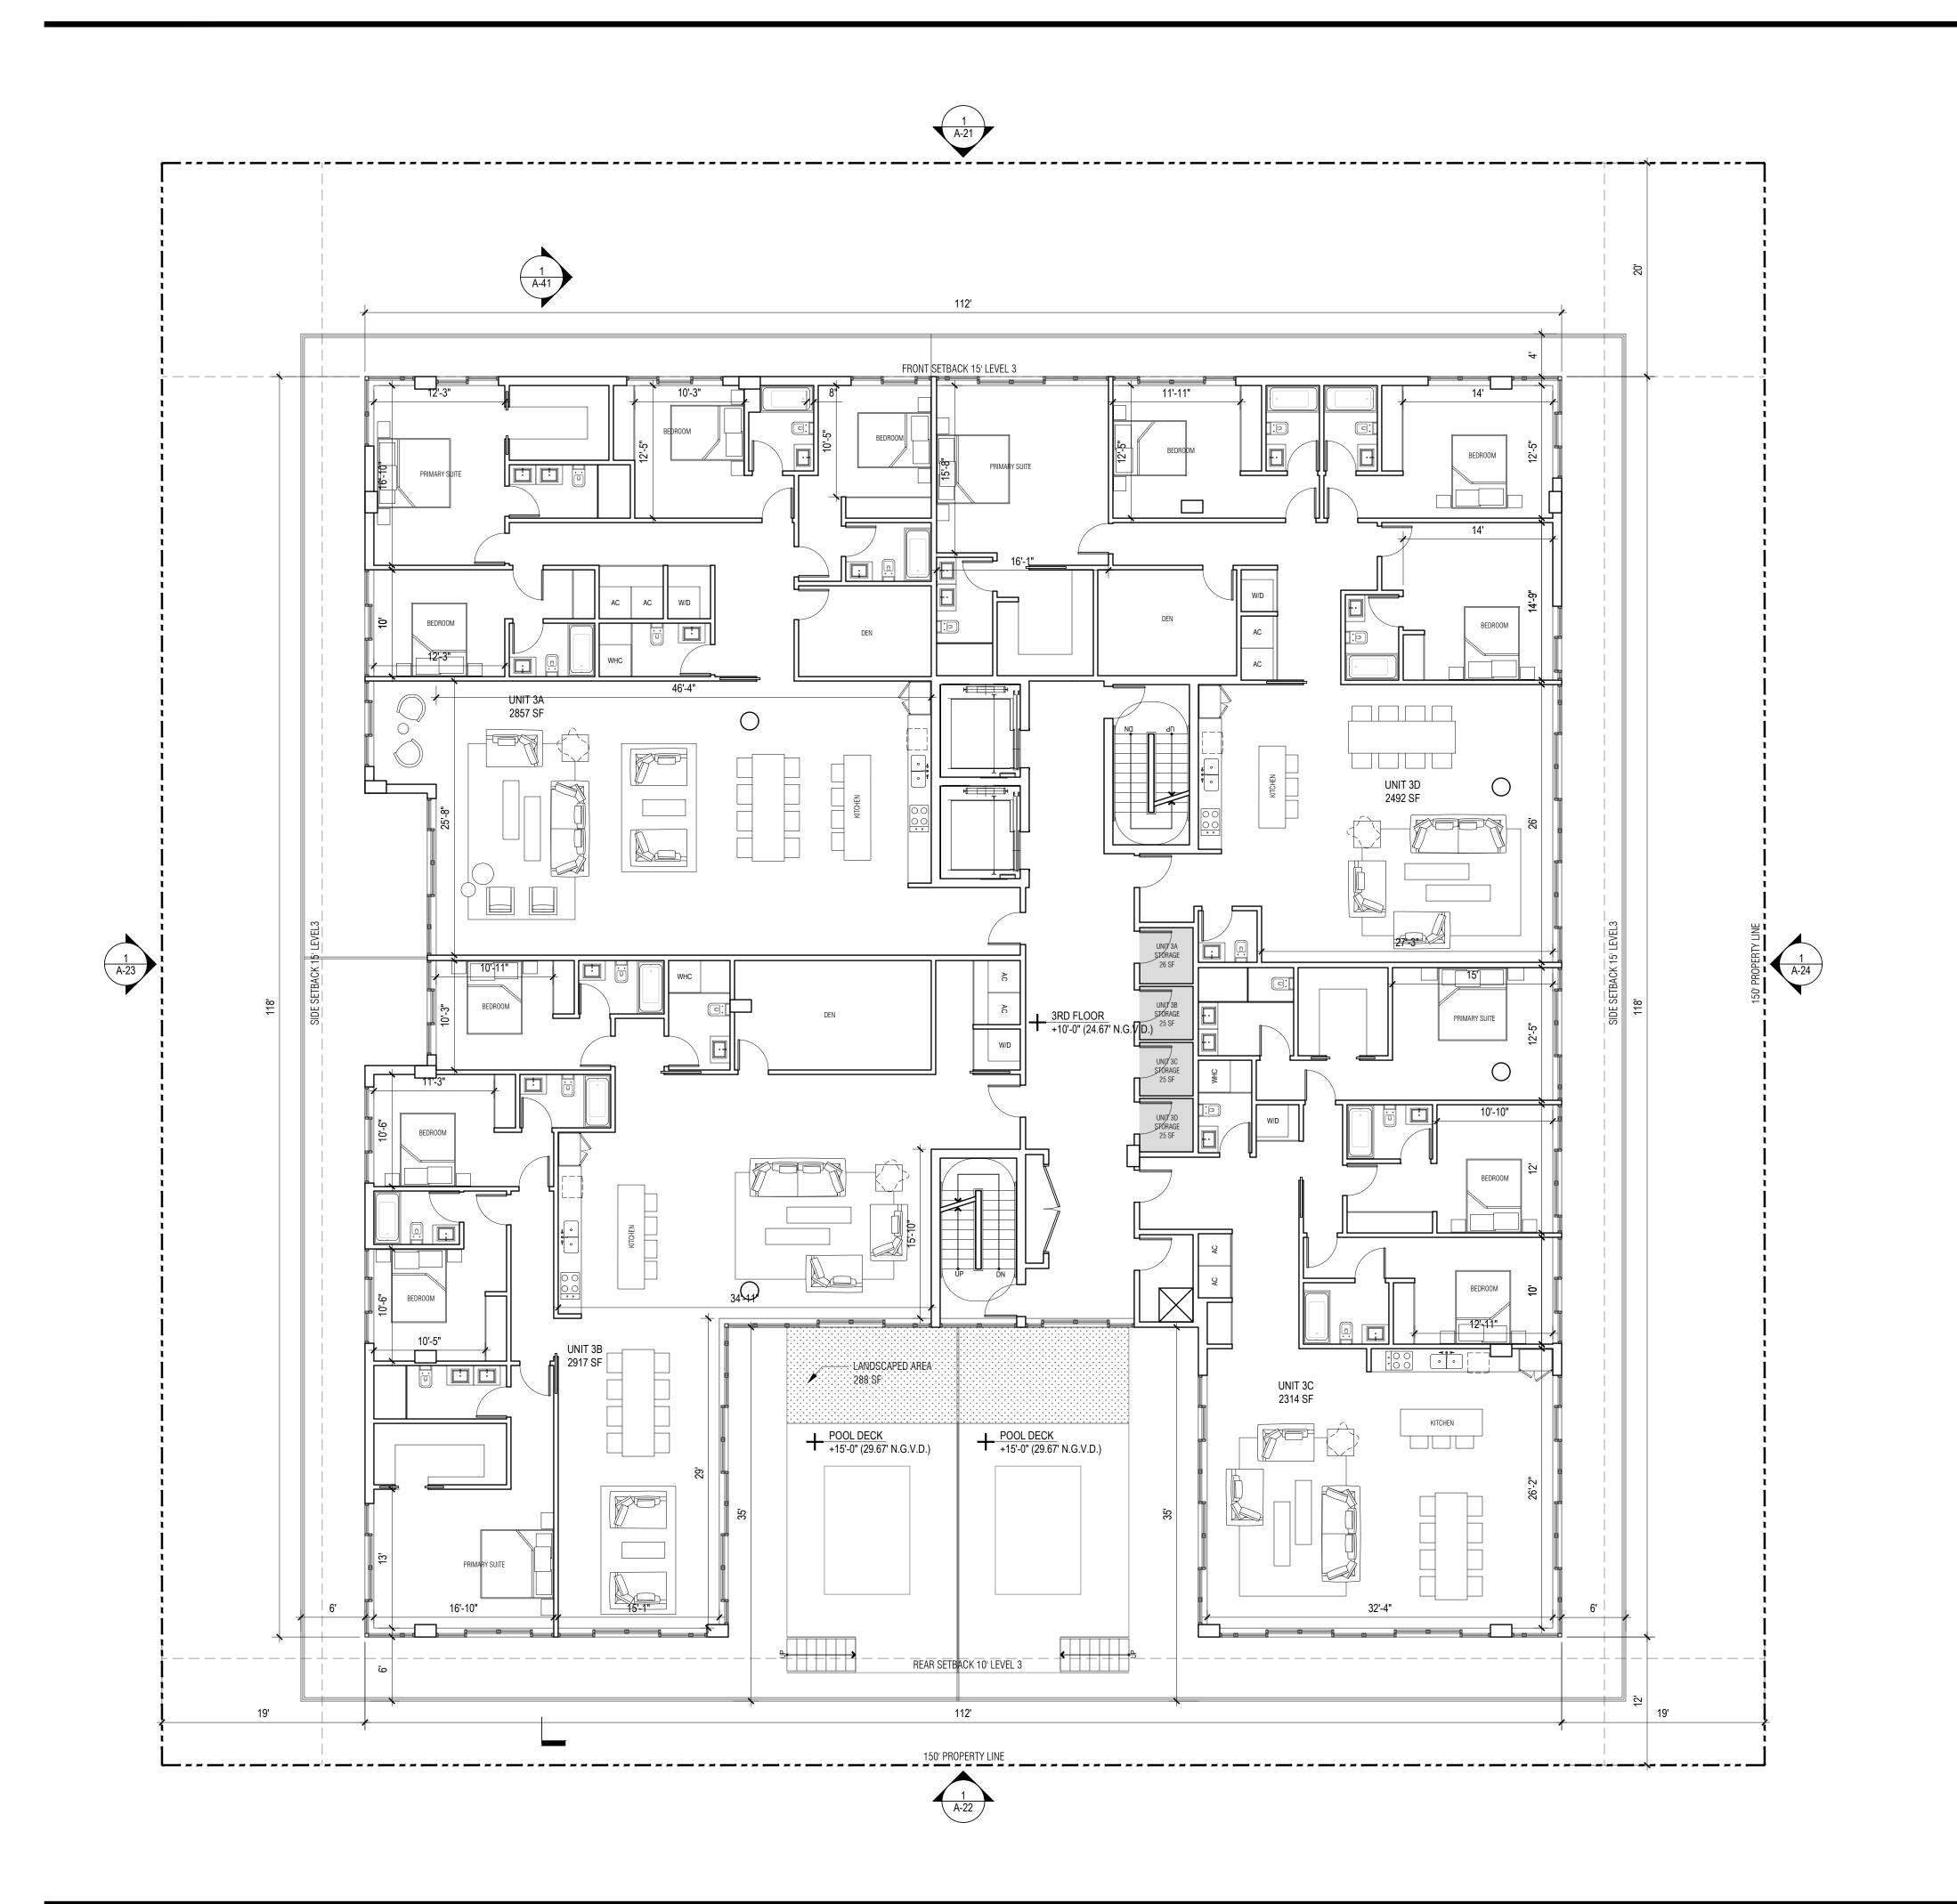

BHI 1130-1140 100TH ST

1130-1140 100TH STREET, BAY HARBOR ISLANDS, FL 33154

DEVELOPER: Redhoek + Partners

138 PIONEER STREET BROOKLYN, NY 11231 T: 718.852.8162

DESIGNER: Fab 314 architecture workshop HAYESOD STREET 2 #121 TEL AVIV-YAFO, 6816721, IL

T: 972-50-888-2629 DESIGNER: PLISKIN ARCHITECTURE PLLC

233 BROADWAY, SUITE 2030 NEW YORK, NY 10279 T: 212-899-9885

ARCHITECT: CARL LEVIN ARCHITECTURE + DESIGN 3390 MARY STREET, SUITE 135 COCONUT GROVE, FL 33133

CIVIL: Nga engineers inc. 11231 SW 88TH ST., UNIT D-114 MIAMI, FL 33176 T: 305 200 6701

T: 305 442 3118

LANDSCAPE: Strata Landscape architecture 1906 TIGERTAIL AVE MIAMI, FL 33133

T: 305 747 9336

LIGHTING: Power & Lighting Systems, Inc. 3832 SHIPPING AVE. MIAMI, FL 33146 T: 305 444 8520


DOB APPROVAL STAMP

DOB APPROVAL SCAN

**KEY PLAN** 

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**PROJECT NUMBER** 2218


TITLE 3RD FLOOR FLOOR PLAN

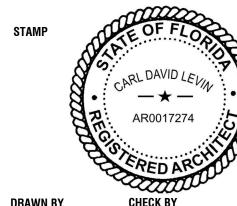DRAWING NO.

3RD FLOOR PLAN
SCALE: 1/8" =1' - 0"

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PAGE No. \_\_\_\_\_ 0F \_\_\_\_\_

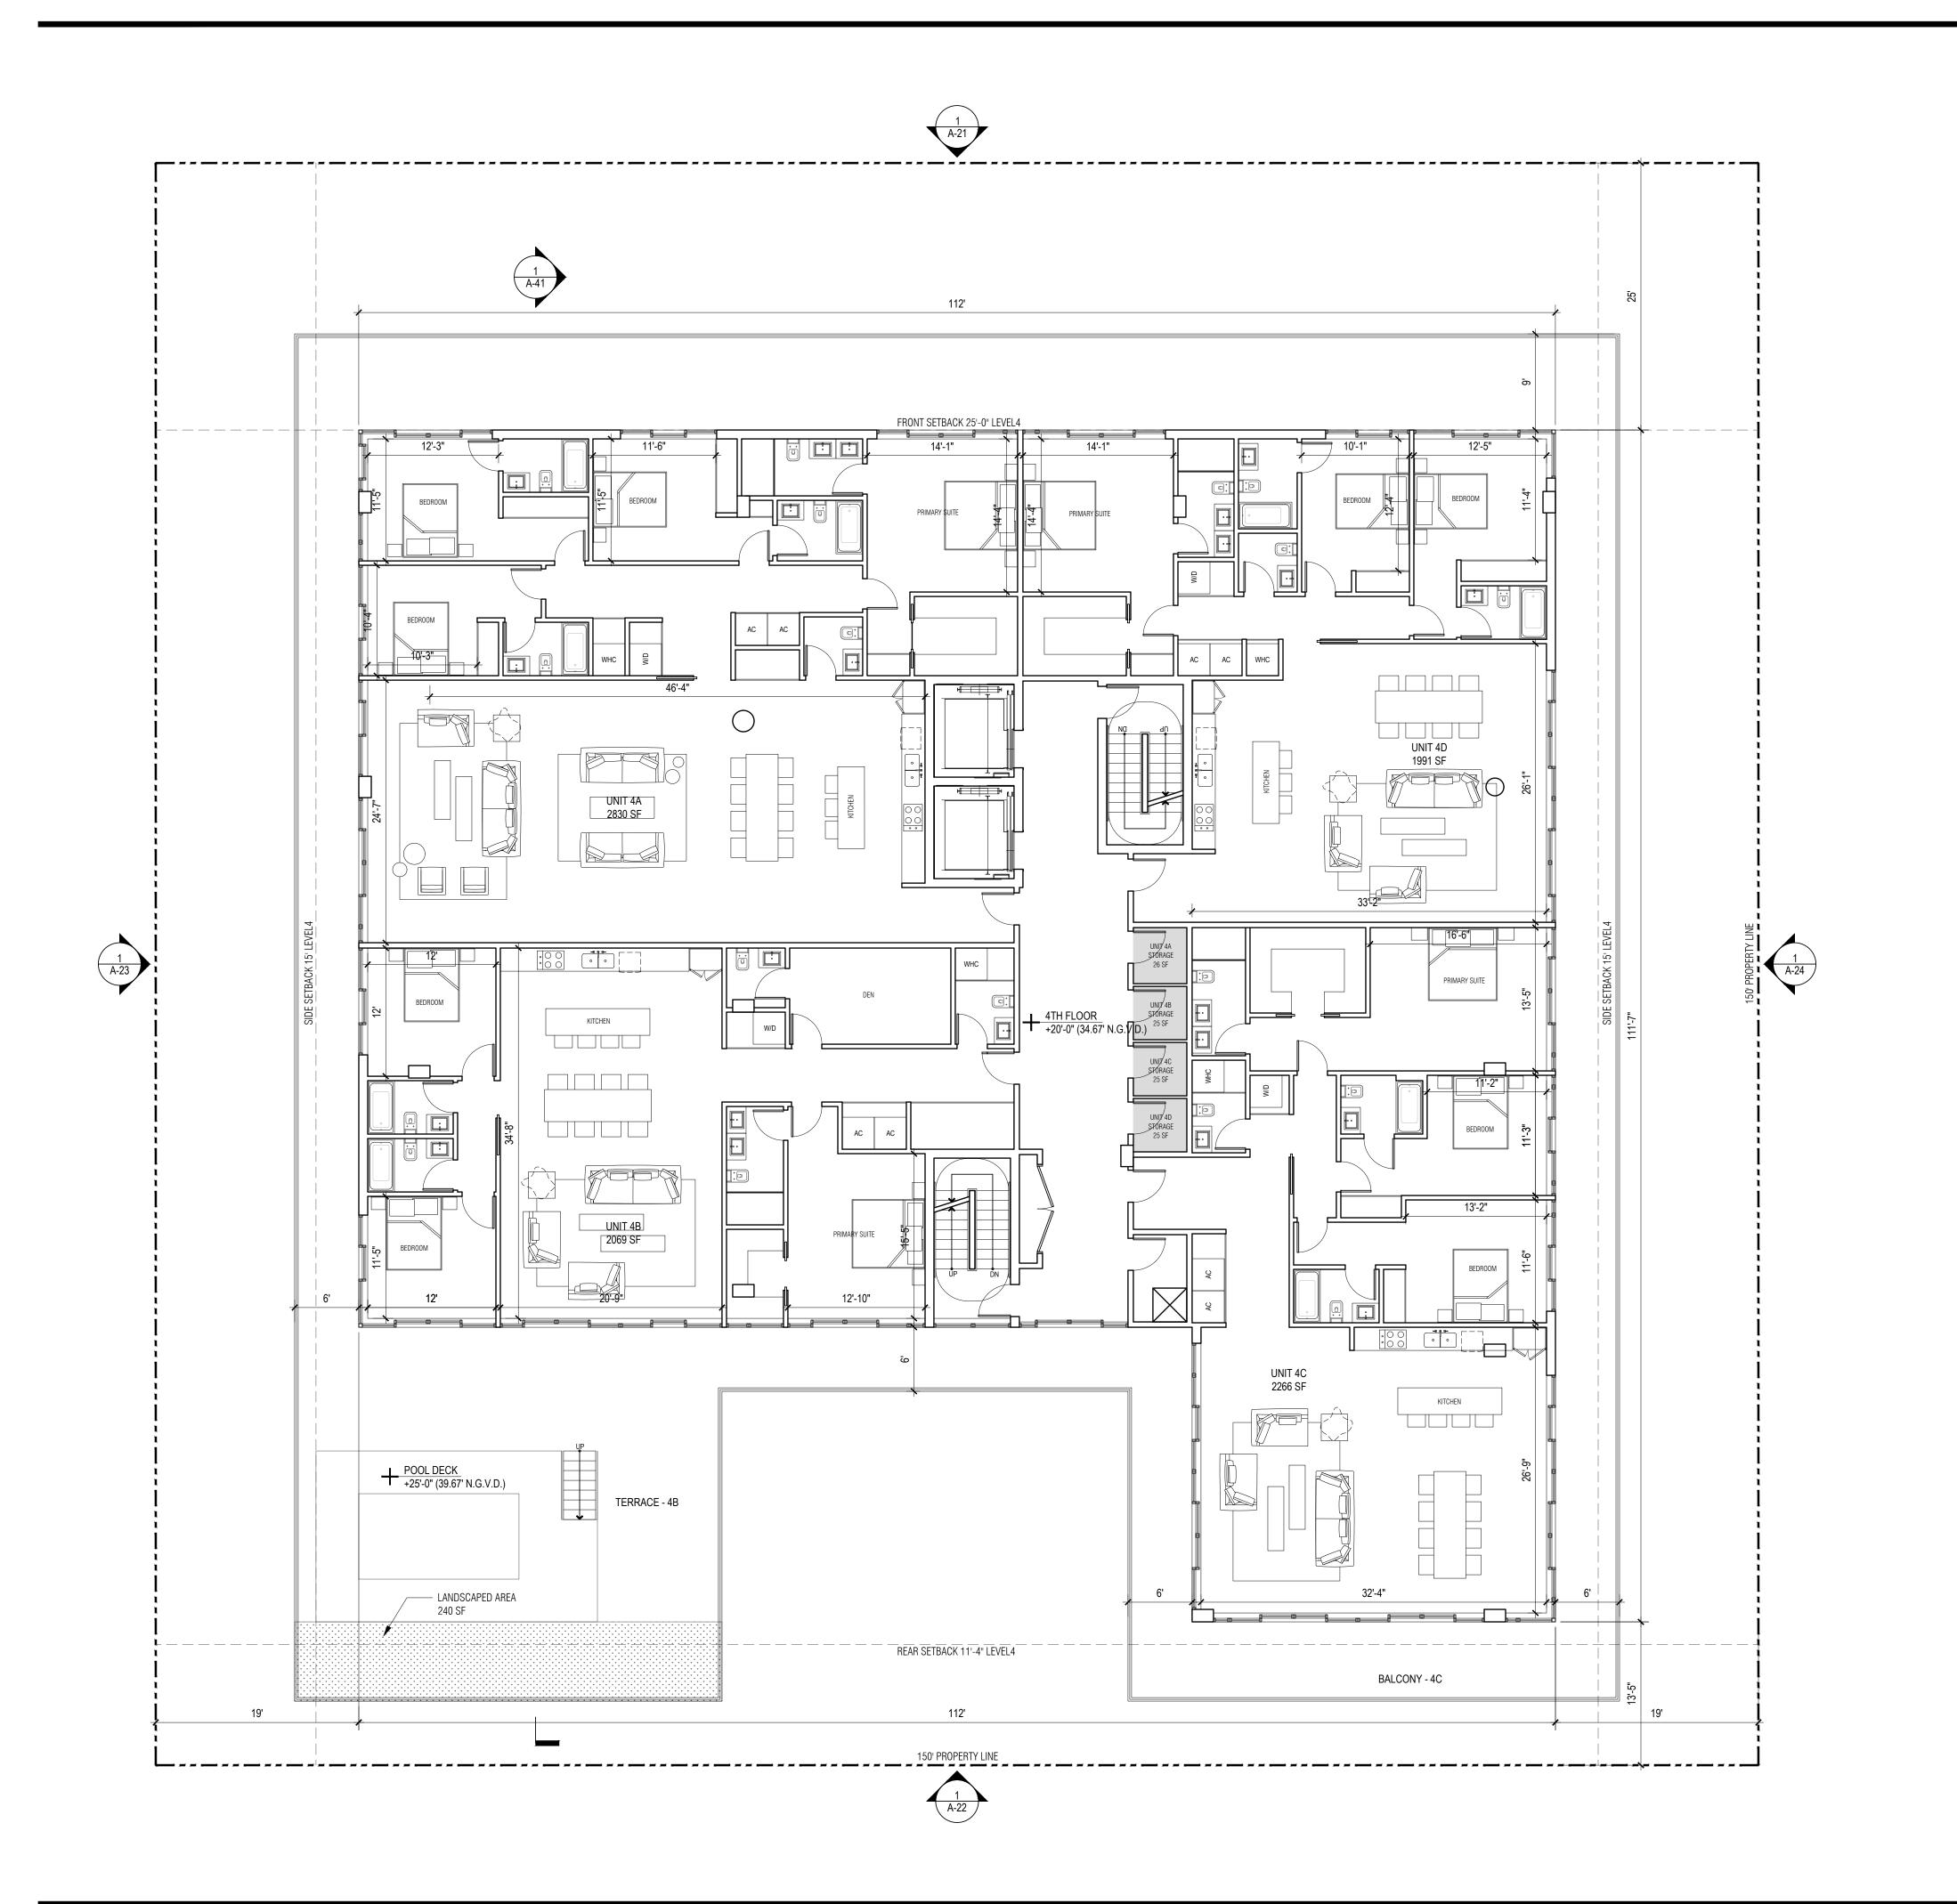

1130-1140 100TH STREET, BAY HARBOR ISLANDS, FL 33154

DEVELOPER: Redhoek + Partners

138 PIONEER STREET BROOKLYN, NY 11231 T: 718.852.8162

DESIGNER: Fab 314 architecture workshop HAYESOD STREET 2 #121 TEL AVIV-YAFO, 6816721, IL T: 972-50-888-2629

DESIGNER: PLISKIN ARCHITECTURE PLLC

233 BROADWAY, SUITE 2030 NEW YORK, NY 10279 T: 212-899-9885

ARCHITECT: CARL LEVIN ARCHITECTURE + DESIGN 3390 MARY STREET, SUITE 135 COCONUT GROVE, FL 33133 T: 305 442 3118

CIVIL: Nga engineers inc. 11231 SW 88TH ST., UNIT D-114 MIAMI, FL 33176 T: 305 200 6701

LANDSCAPE: Strata Landscape architecture 1906 Tigertail Ave MIAMI, FL 33133

LIGHTING: Power & Lighting Systems, Inc. 3832 SHIPPING AVE. MIAMI, FL 33146 T: 305 444 8520

T: 305 747 9336


DOB APPROVAL STAMP

DOB APPROVAL SCAN

**KEY PLAN** 

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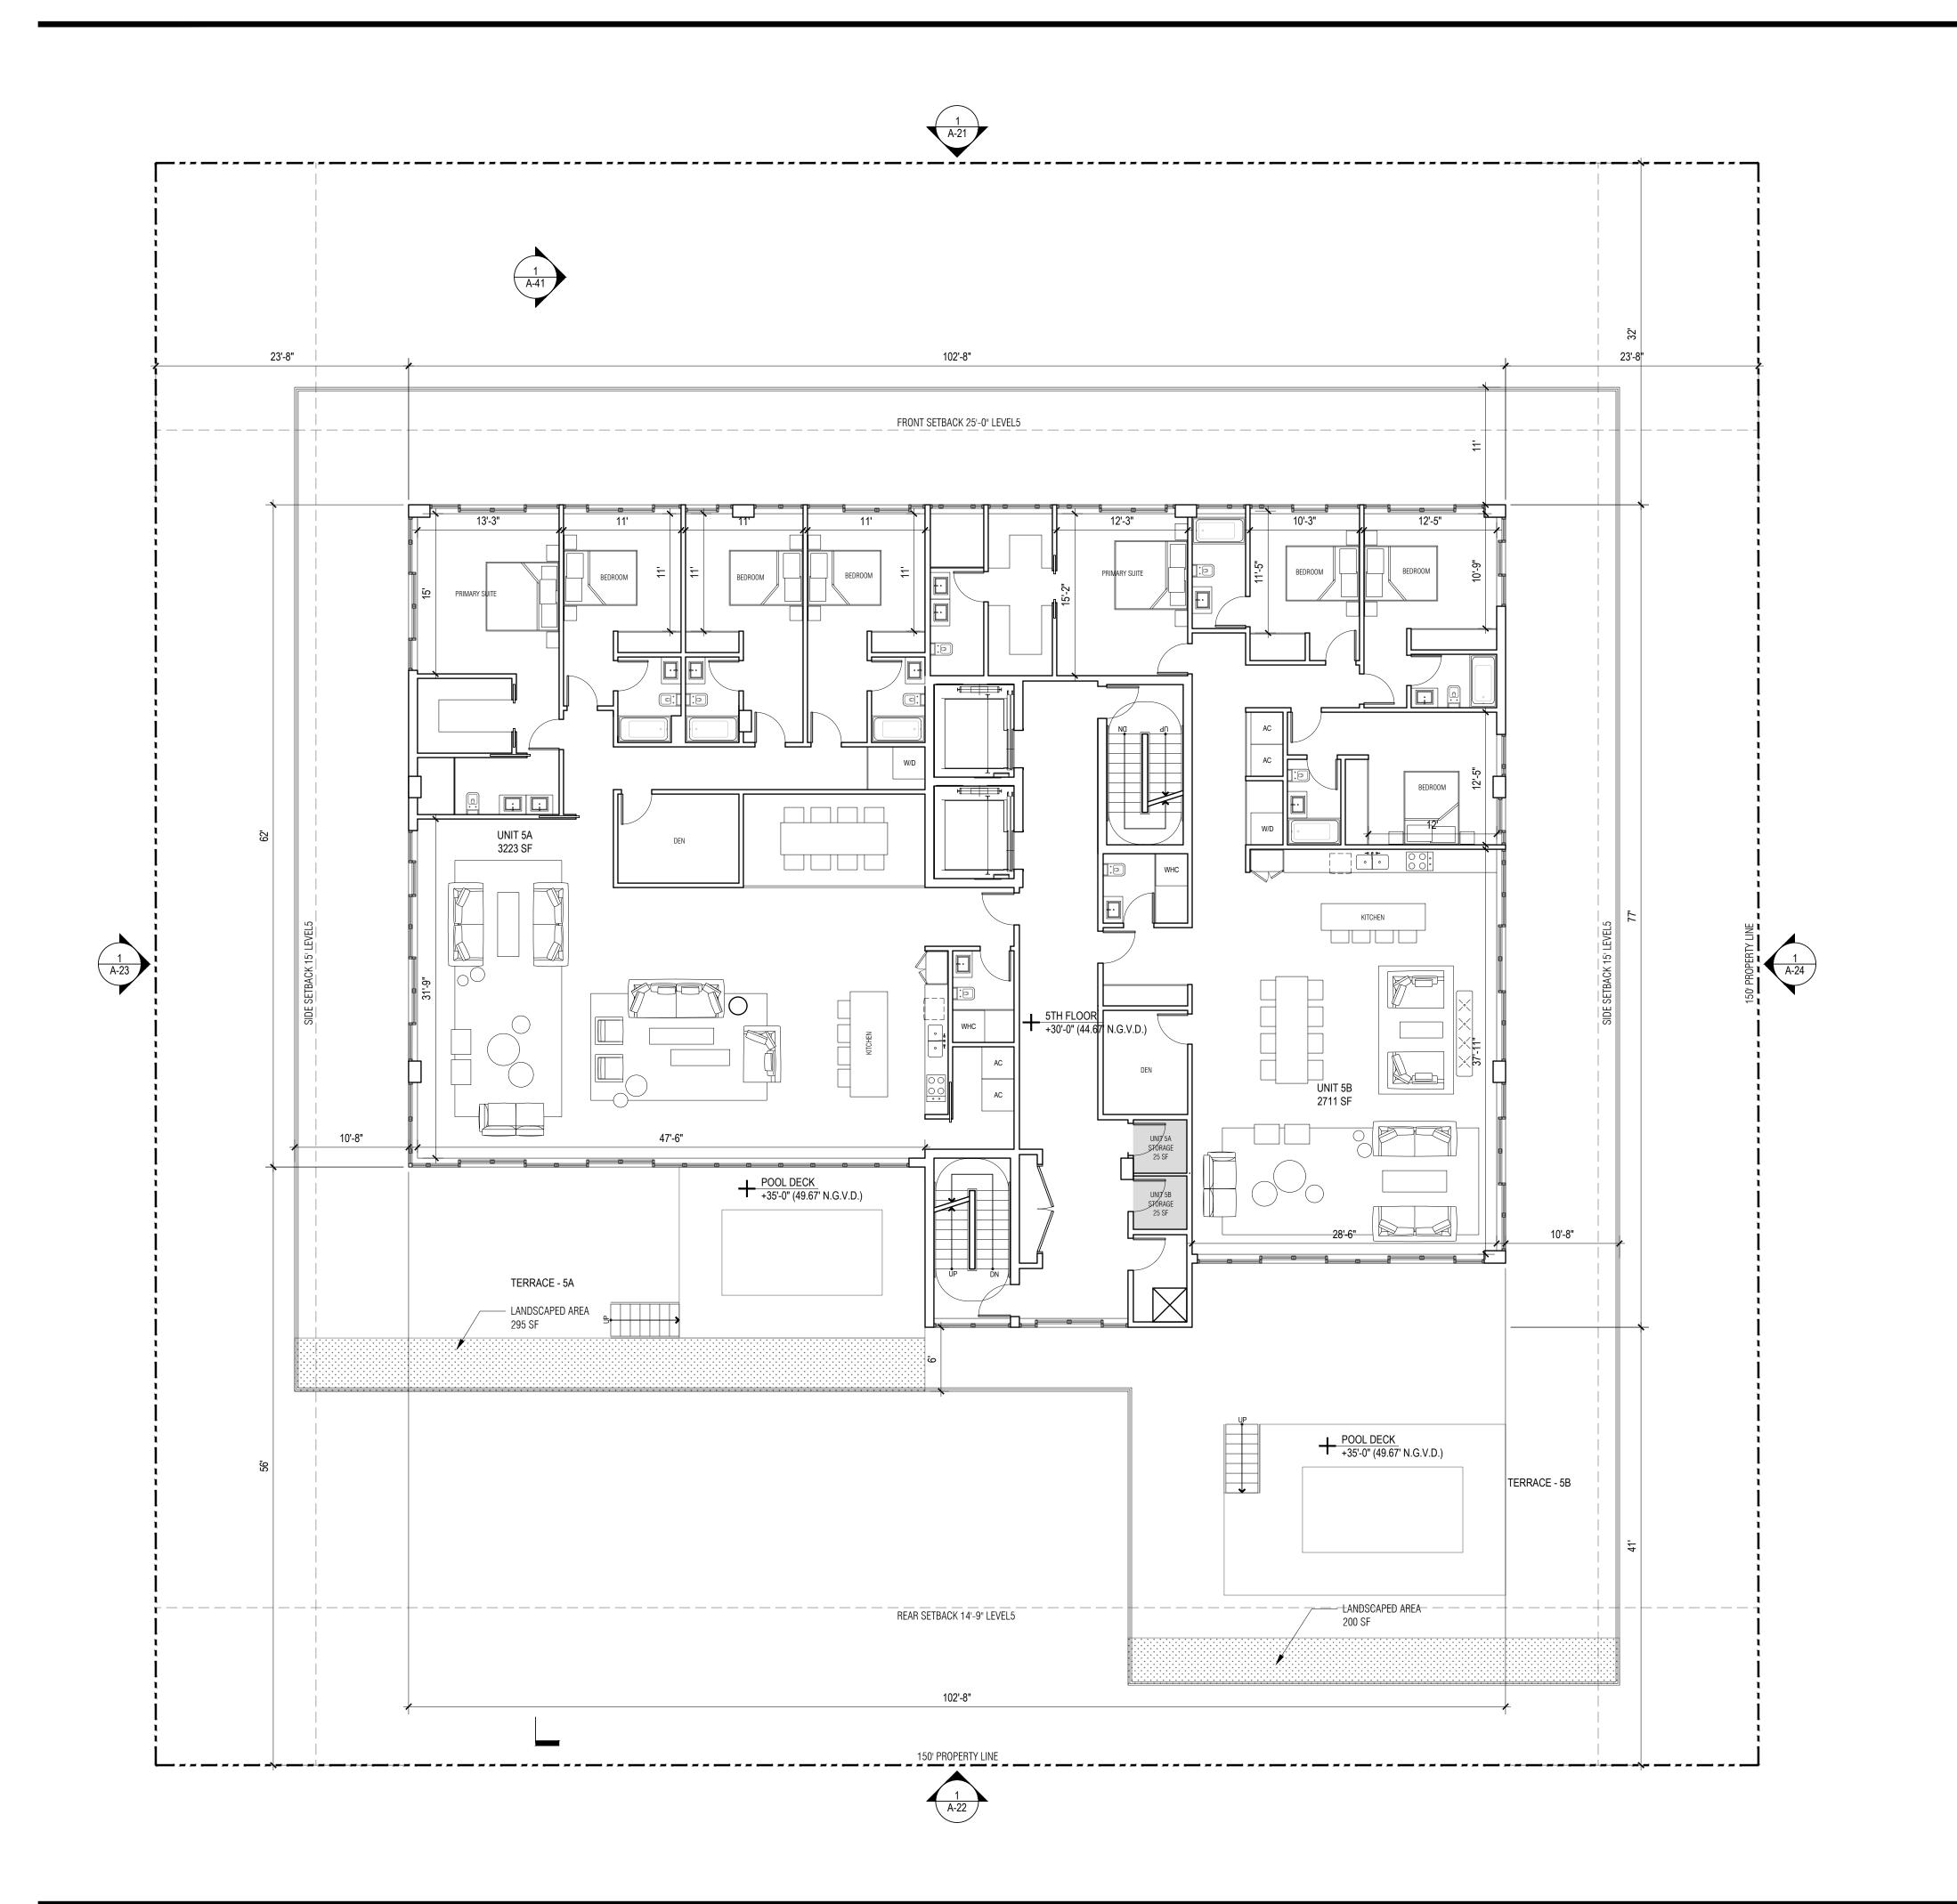
**PROJECT NUMBER** 2218

TITLE 4TH FLOOR FLOOR PLAN

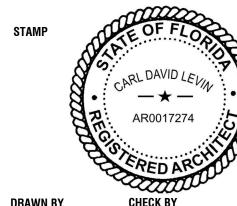DRAWING NO.

4TH FLOOR PLAN

SCALE: 1/8" =1' - 0"



1130-1140 100TH STREET, BAY HARBOR ISLANDS, FL 33154

DEVELOPER: Redhoek + Partners

138 PIONEER STREET BROOKLYN, NY 11231 T: 718.852.8162

DESIGNER: Fab 314 architecture workshop HAYESOD STREET 2 #121 TEL AVIV-YAFO, 6816721, IL T: 972-50-888-2629

DESIGNER: PLISKIN ARCHITECTURE PLLC 233 BROADWAY, SUITE 2030

NEW YORK, NY 10279 T: 212-899-9885

ARCHITECT: Carl Levin Architecture + Design 3390 MARY STREET, SUITE 135 COCONUT GROVE, FL 33133

T: 305 442 3118 CIVIL: Nga engineers inc. 11231 SW 88TH ST., UNIT D-114

MIAMI, FL 33176 T: 305 200 6701 LANDSCAPE: Strata Landscape architecture

1906 TIGERTAIL AVE MIAMI, FL 33133 T: 305 747 9336


LIGHTING: Power & Lighting Systems, Inc. 3832 SHIPPING AVE. MIAMI, FL 33146 T: 305 444 8520

DOB APPROVAL STAMP

DOB APPROVAL SCAN

**KEY PLAN** 

. 01 ISSUE FOR SITE PLAN REVIEW . 12, 29, 2022

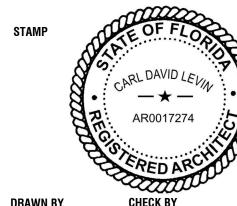


**PROJECT NUMBER** 2218

TITLE 5TH FLOOR FLOOR PLAN

DRAWING NO.

SCALE: 1/8" =1' - 0"

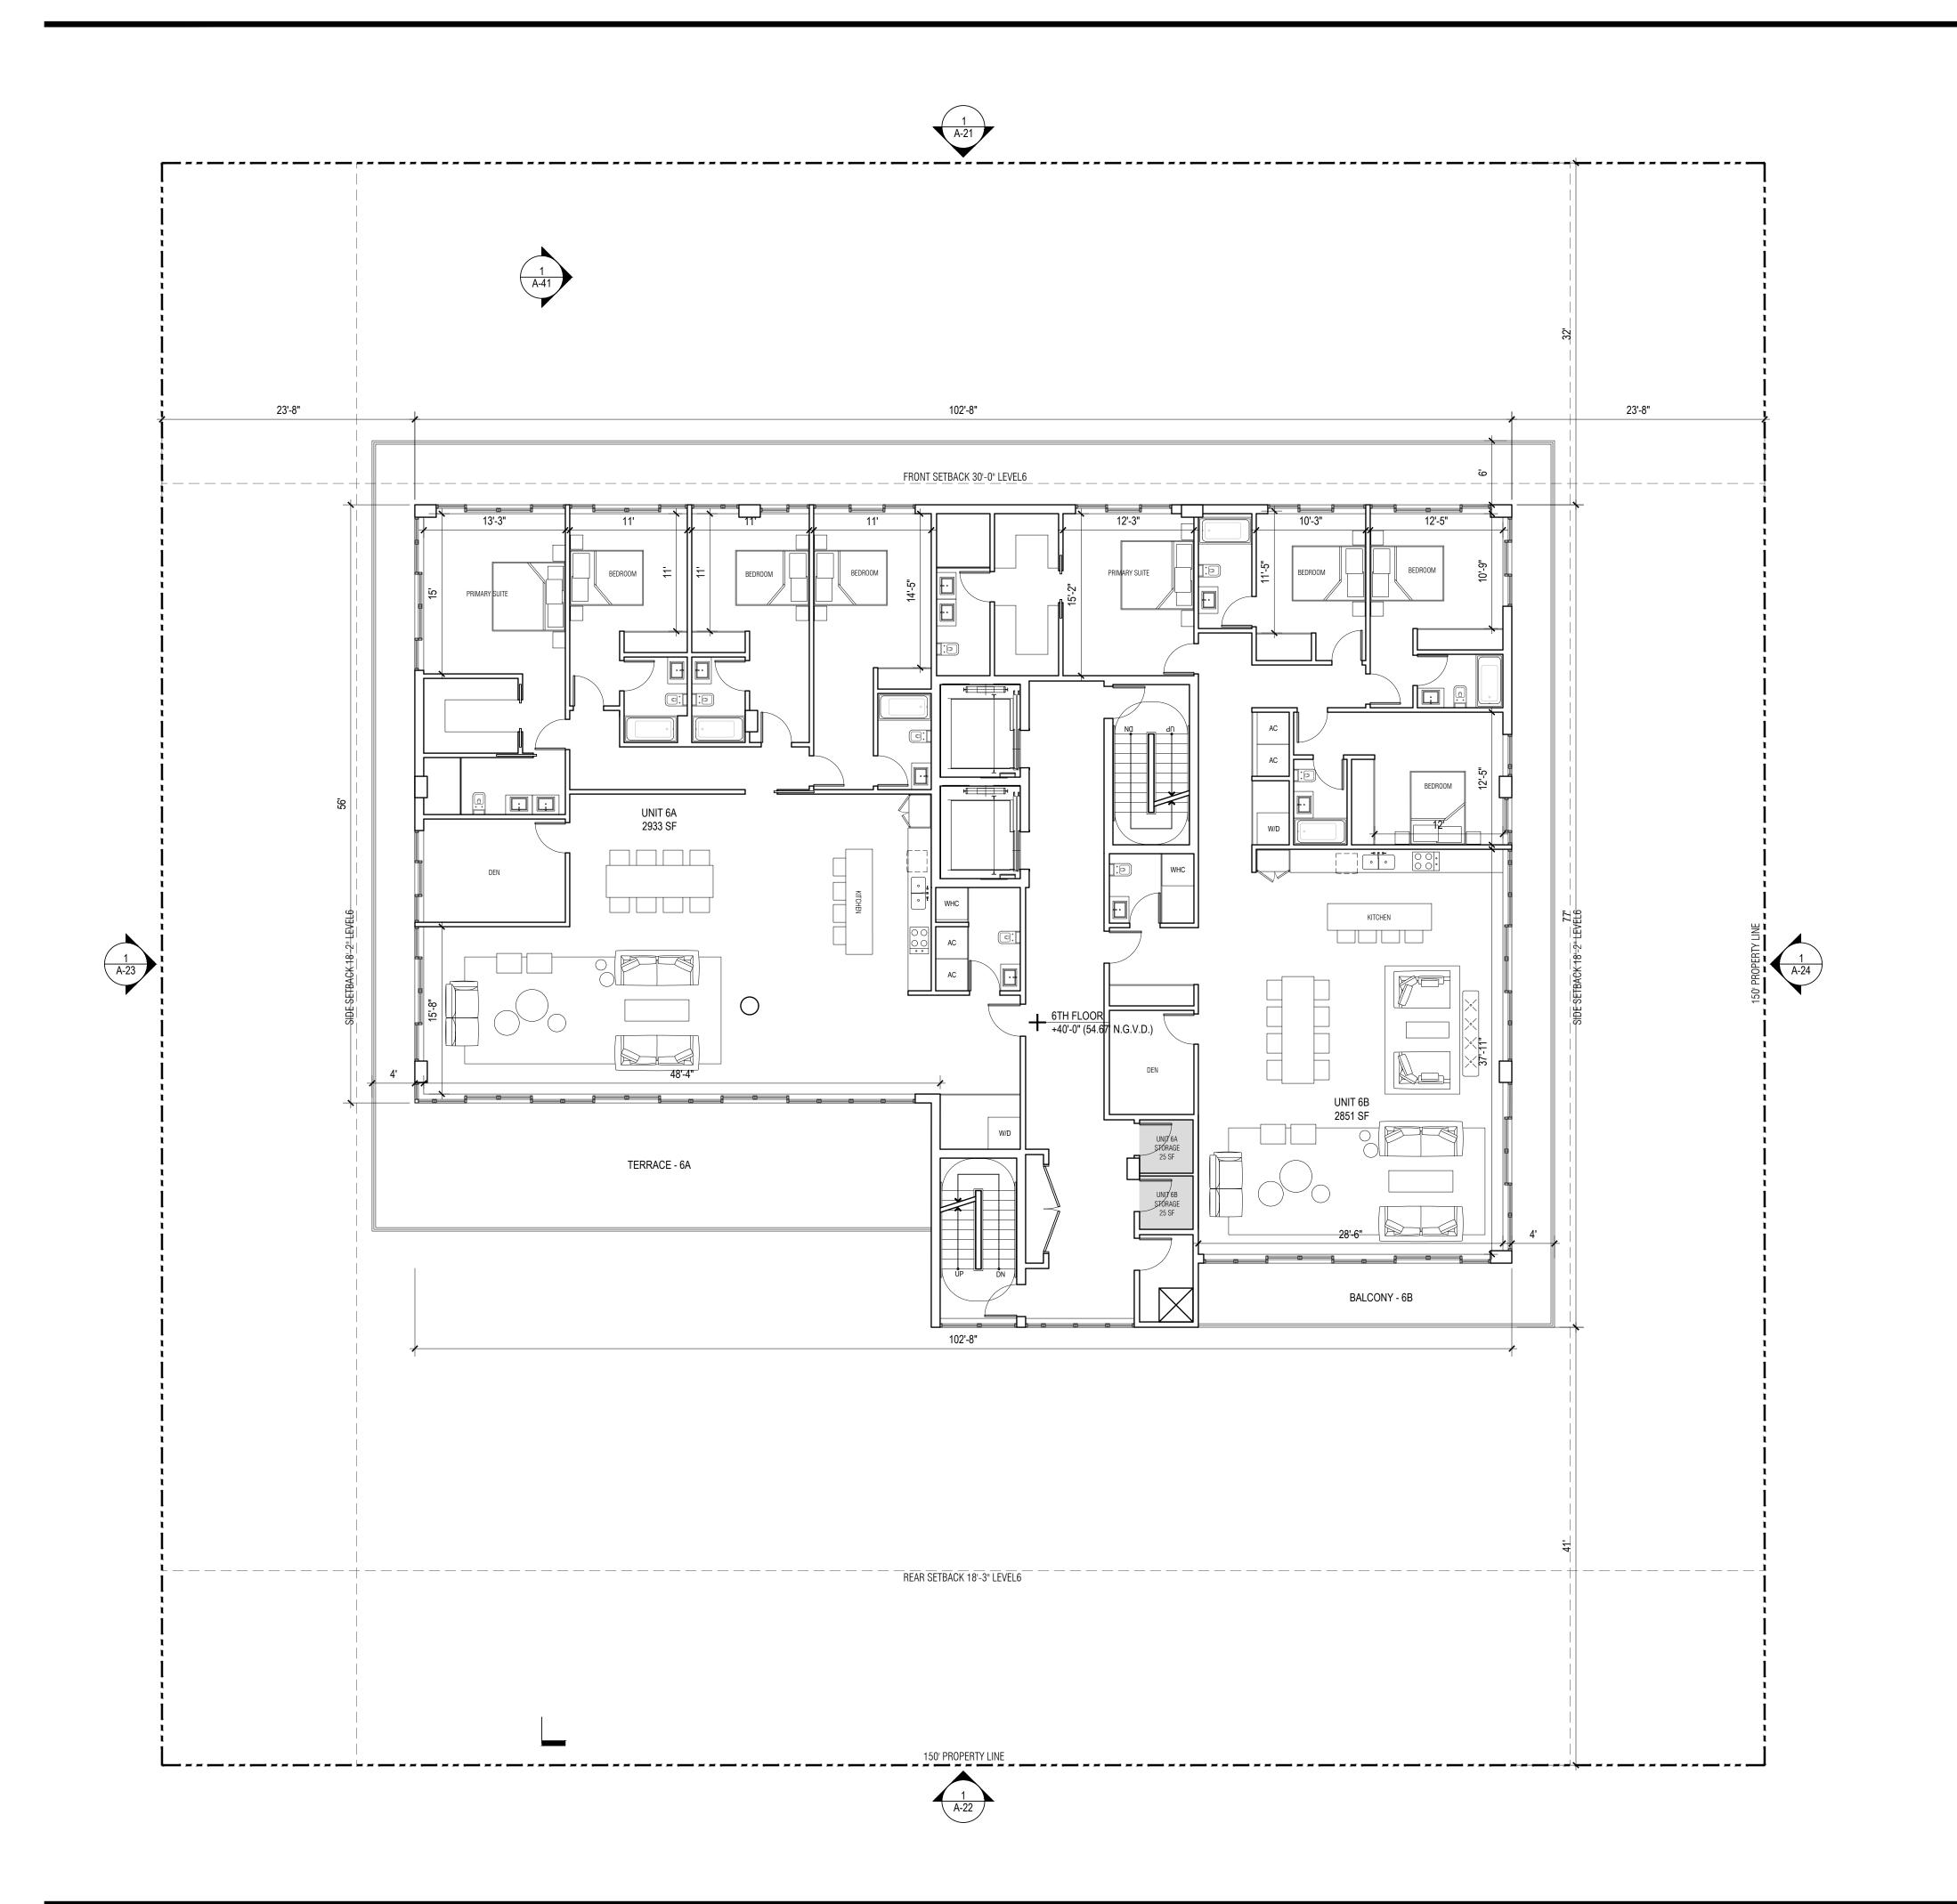

1130-1140 100TH STREET, BAY HARBOR ISLANDS, FL 33154

DEVELOPER: Redhoek + Partners

138 PIONEER STREET BROOKLYN, NY 11231 T: 718.852.8162

DESIGNER: Fab 314 architecture workshop HAYESOD STREET 2 #121 TEL AVIV-YAFO, 6816721, IL T: 972-50-888-2629

DESIGNER: Pliskin architecture Pllc

233 BROADWAY, SUITE 2030

NEW YORK, NY 10279 T: 212-899-9885

ARCHITECT: Carl Levin Architecture + Design 3390 MARY STREET, SUITE 135 COCONUT GROVE, FL 33133 T: 305 442 3118

CIVIL: Nga engineers inc. 11231 SW 88TH ST., UNIT D-114 MIAMI, FL 33176 T: 305 200 6701

LANDSCAPE: Strata Landscape architecture 1906 TIGERTAIL AVE MIAMI, FL 33133


T: 305 747 9336

LIGHTING: Power & Lighting Systems, Inc. 3832 SHIPPING AVE. MIAMI, FL 33146 T: 305 444 8520

DOB APPROVAL STAMP

DOB APPROVAL SCAN


. 01 ISSUE FOR SITE PLAN REVIEW . 12. 29. 2022

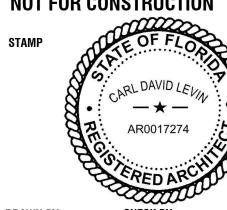

**PROJECT NUMBER** 2218

TITLE RTH FLOOR FLOOR PLAN

DRAWING NO.

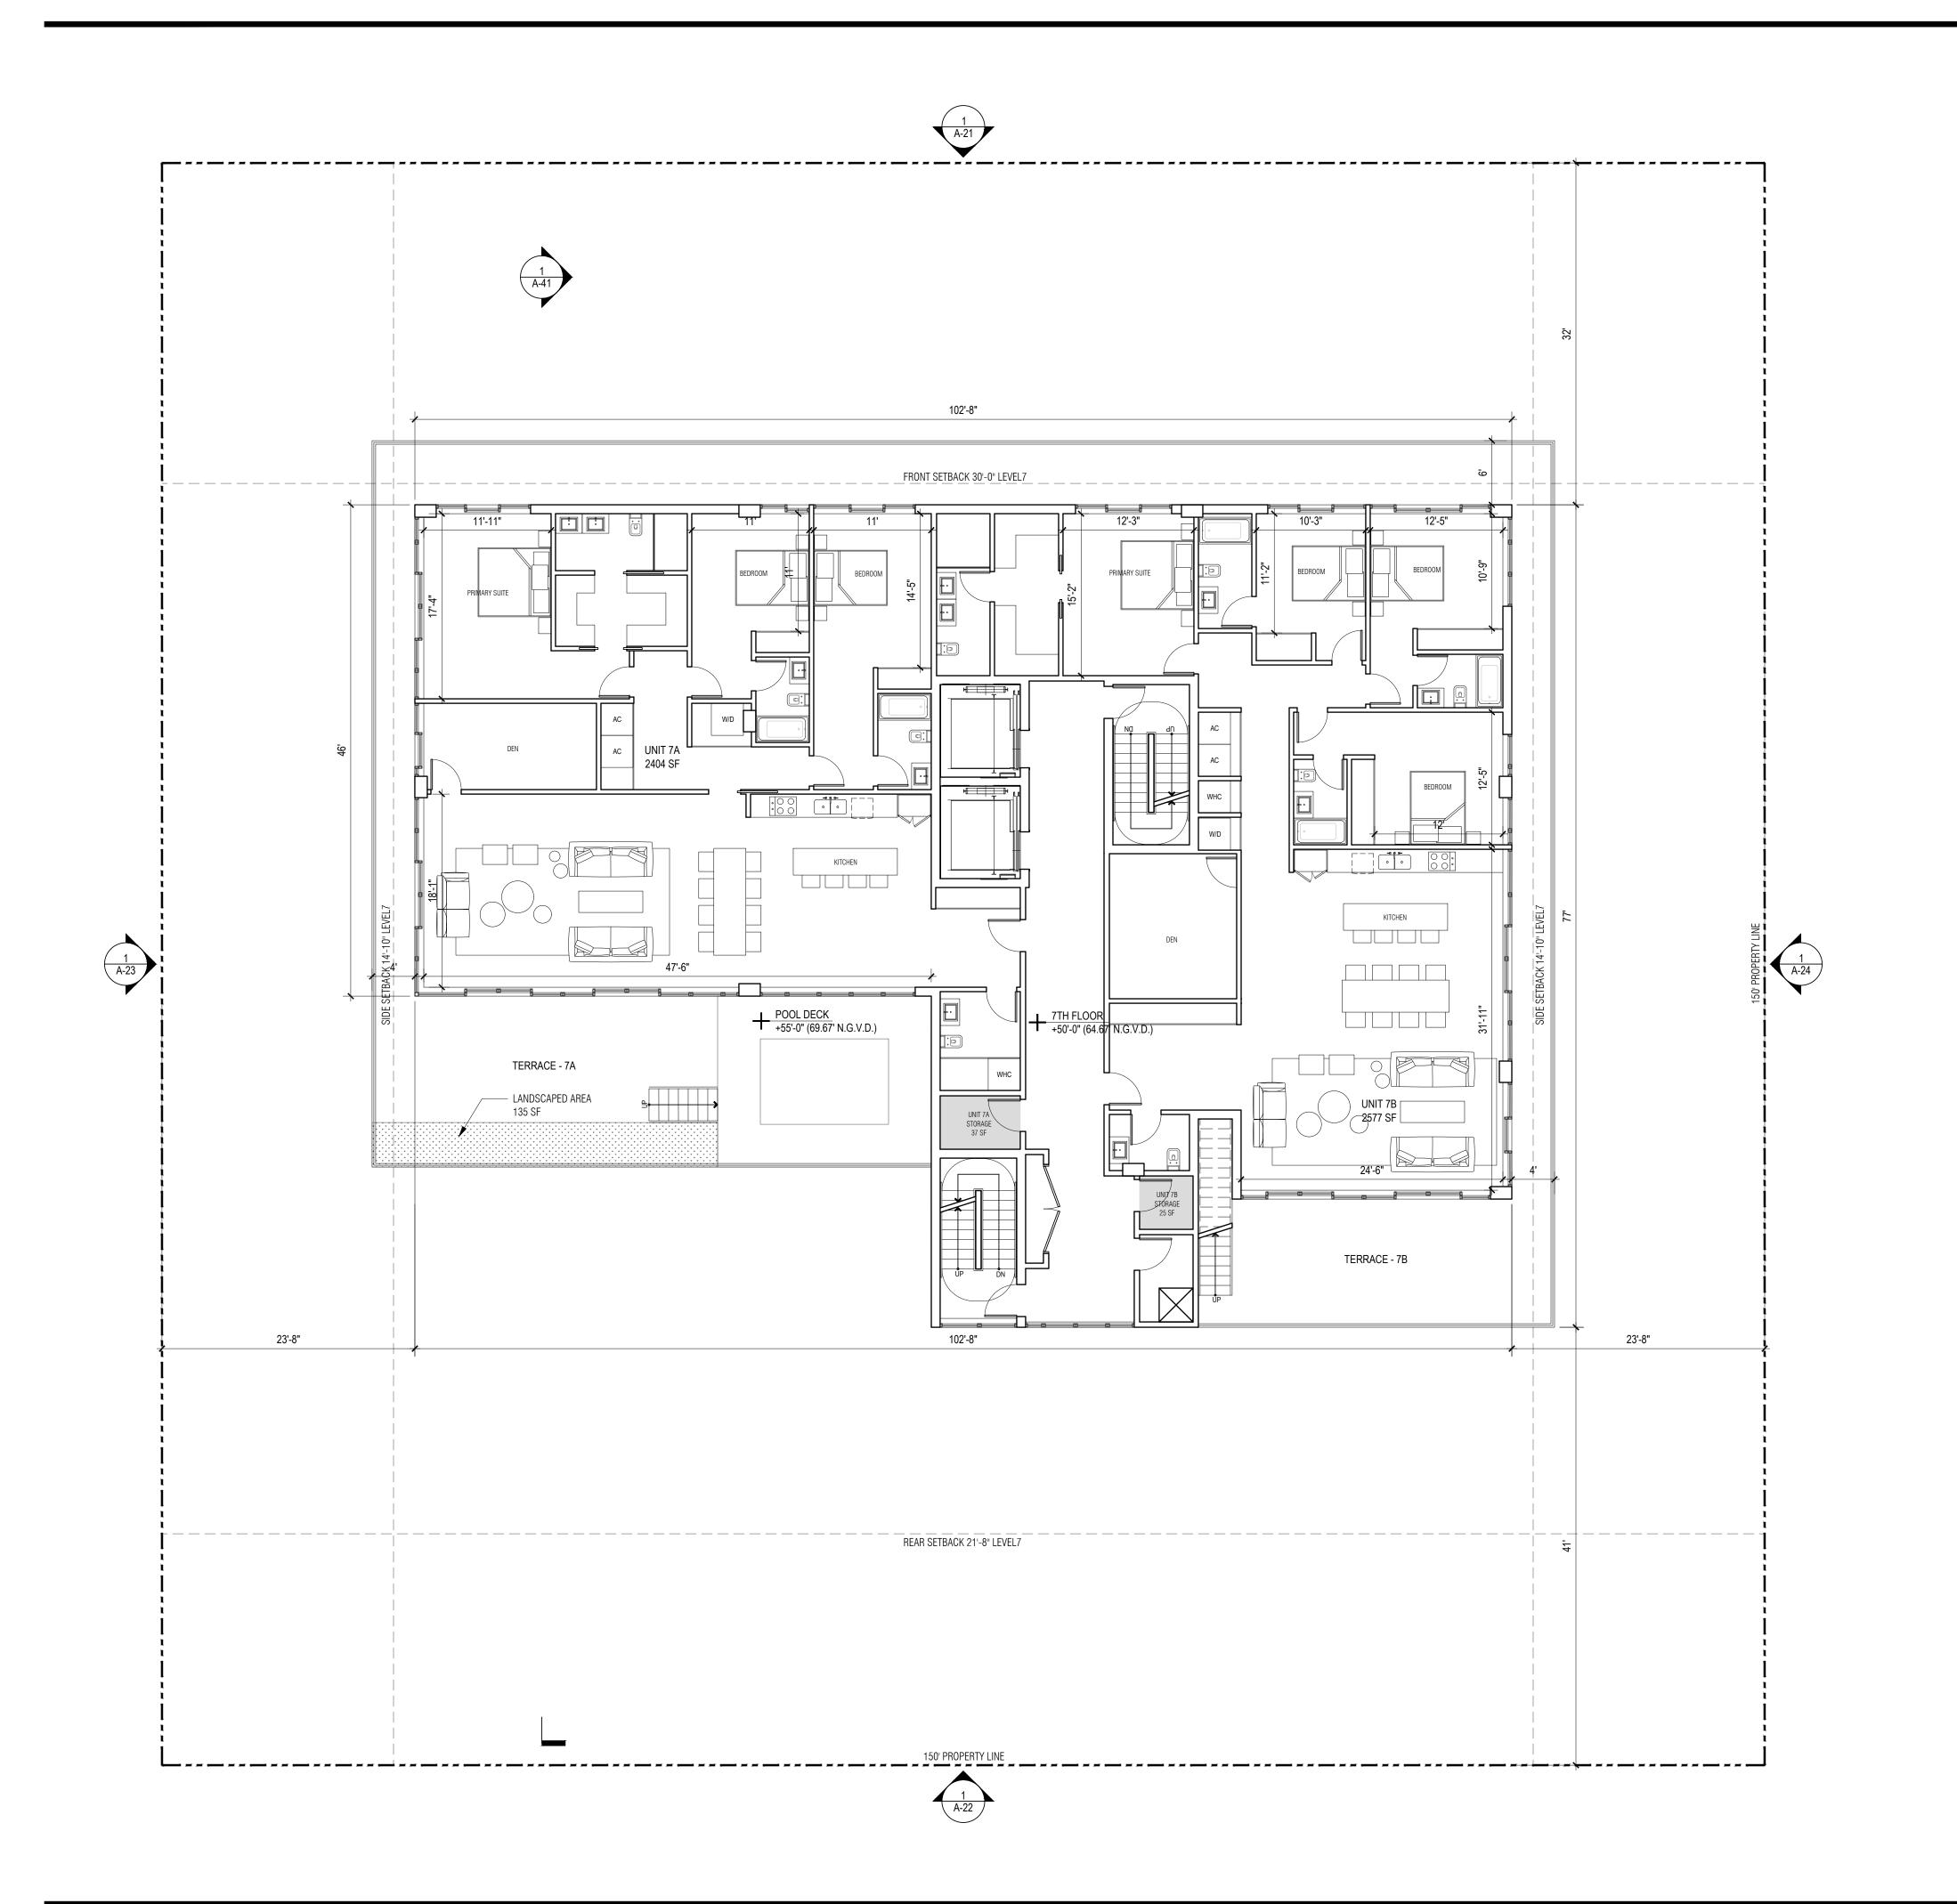

1130-1140 100TH STREET, BAY HARBOR ISLANDS, FL 33154

DEVELOPER: Redhoek + Partners

138 PIONEER STREET BROOKLYN, NY 11231 T: 718.852.8162

DESIGNER: Fab 314 architecture workshop HAYESOD STREET 2 #121 TEL AVIV-YAFO, 6816721, IL T: 972-50-888-2629

DESIGNER: Pliskin architecture Pllc

233 BROADWAY, SUITE 2030 NEW YORK, NY 10279 T: 212-899-9885

ARCHITECT: Carl Levin Architecture + Design 3390 MARY STREET, SUITE 135 COCONUT GROVE, FL 33133

T: 305 442 3118 CIVIL: Nga engineers inc.

11231 SW 88TH ST., UNIT D-114 MIAMI, FL 33176 T: 305 200 6701


LANDSCAPE: STRATA LANDSCAPE ARCHITECTURE 1906 TIGERTAIL AVE MIAMI, FL 33133 T: 305 747 9336

LIGHTING: Power & Lighting Systems, Inc. 3832 SHIPPING AVE. MIAMI, FL 33146 T: 305 444 8520

**DOB APPROVAL STAMP** 

DOB APPROVAL SCAN


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**PROJECT NUMBER** 2218

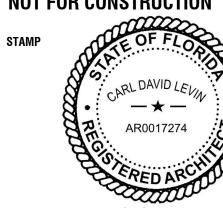TITLE 7TH FLOOR FLOOR PLAN

DRAWING NO.



1130-1140 100TH STREET, BAY HARBOR ISLANDS, FL 33154

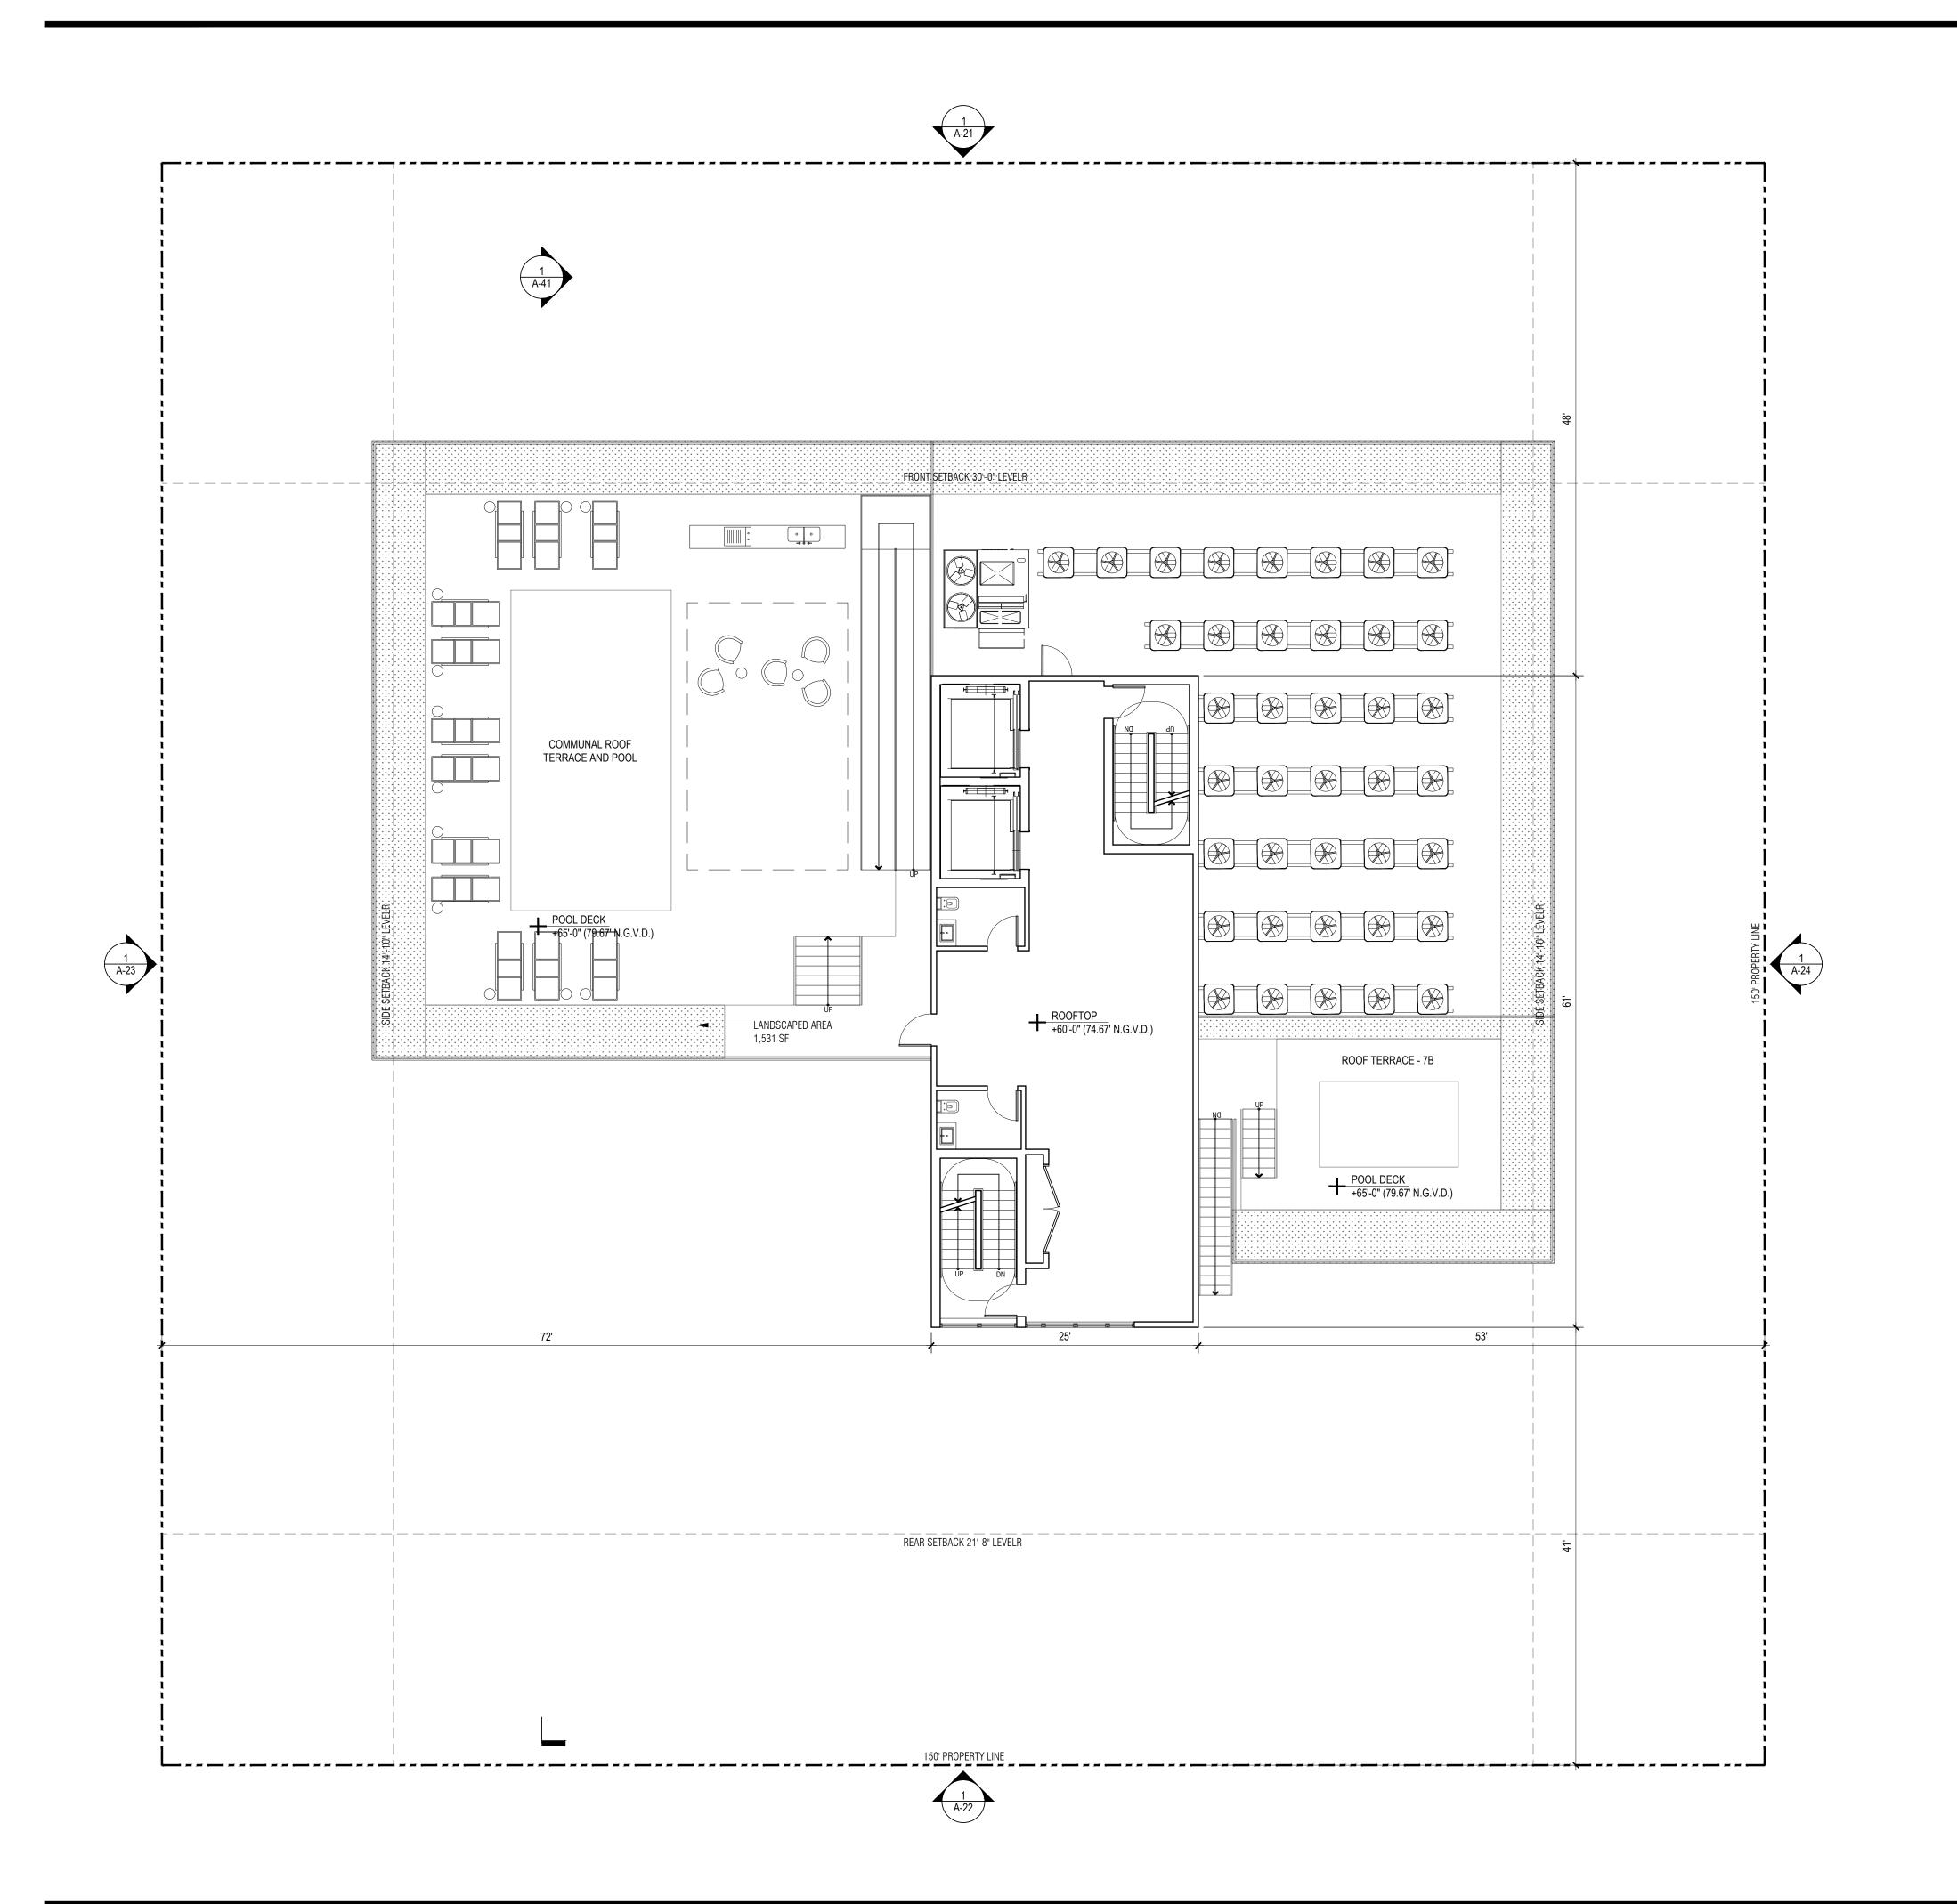DEVELOPER: Redhoek + Partners

138 PIONEER STREET BROOKLYN, NY 11231 T: 718.852.8162

DESIGNER: Fab 314 architecture workshop HAYESOD STREET 2 #121 TEL AVIV-YAFO, 6816721, IL T: 972-50-888-2629

DESIGNER: PLISKIN ARCHITECTURE PLLC

233 BROADWAY, SUITE 2030 NEW YORK, NY 10279 T: 212-899-9885

ARCHITECT: CARL LEVIN ARCHITECTURE + DESIGN 3390 MARY STREET, SUITE 135 COCONUT GROVE, FL 33133

T: 305 442 3118 CIVIL: Nga engineers inc.

11231 SW 88TH ST., UNIT D-114 MIAMI, FL 33176 T: 305 200 6701


LANDSCAPE: STRATA LANDSCAPE ARCHITECTURE 1906 TIGERTAIL AVE MIAMI, FL 33133 T: 305 747 9336

LIGHTING: Power & Lighting Systems, Inc. 3832 SHIPPING AVE. MIAMI, FL 33146 T: 305 444 8520

DOB APPROVAL STAMP

DOB APPROVAL SCAN

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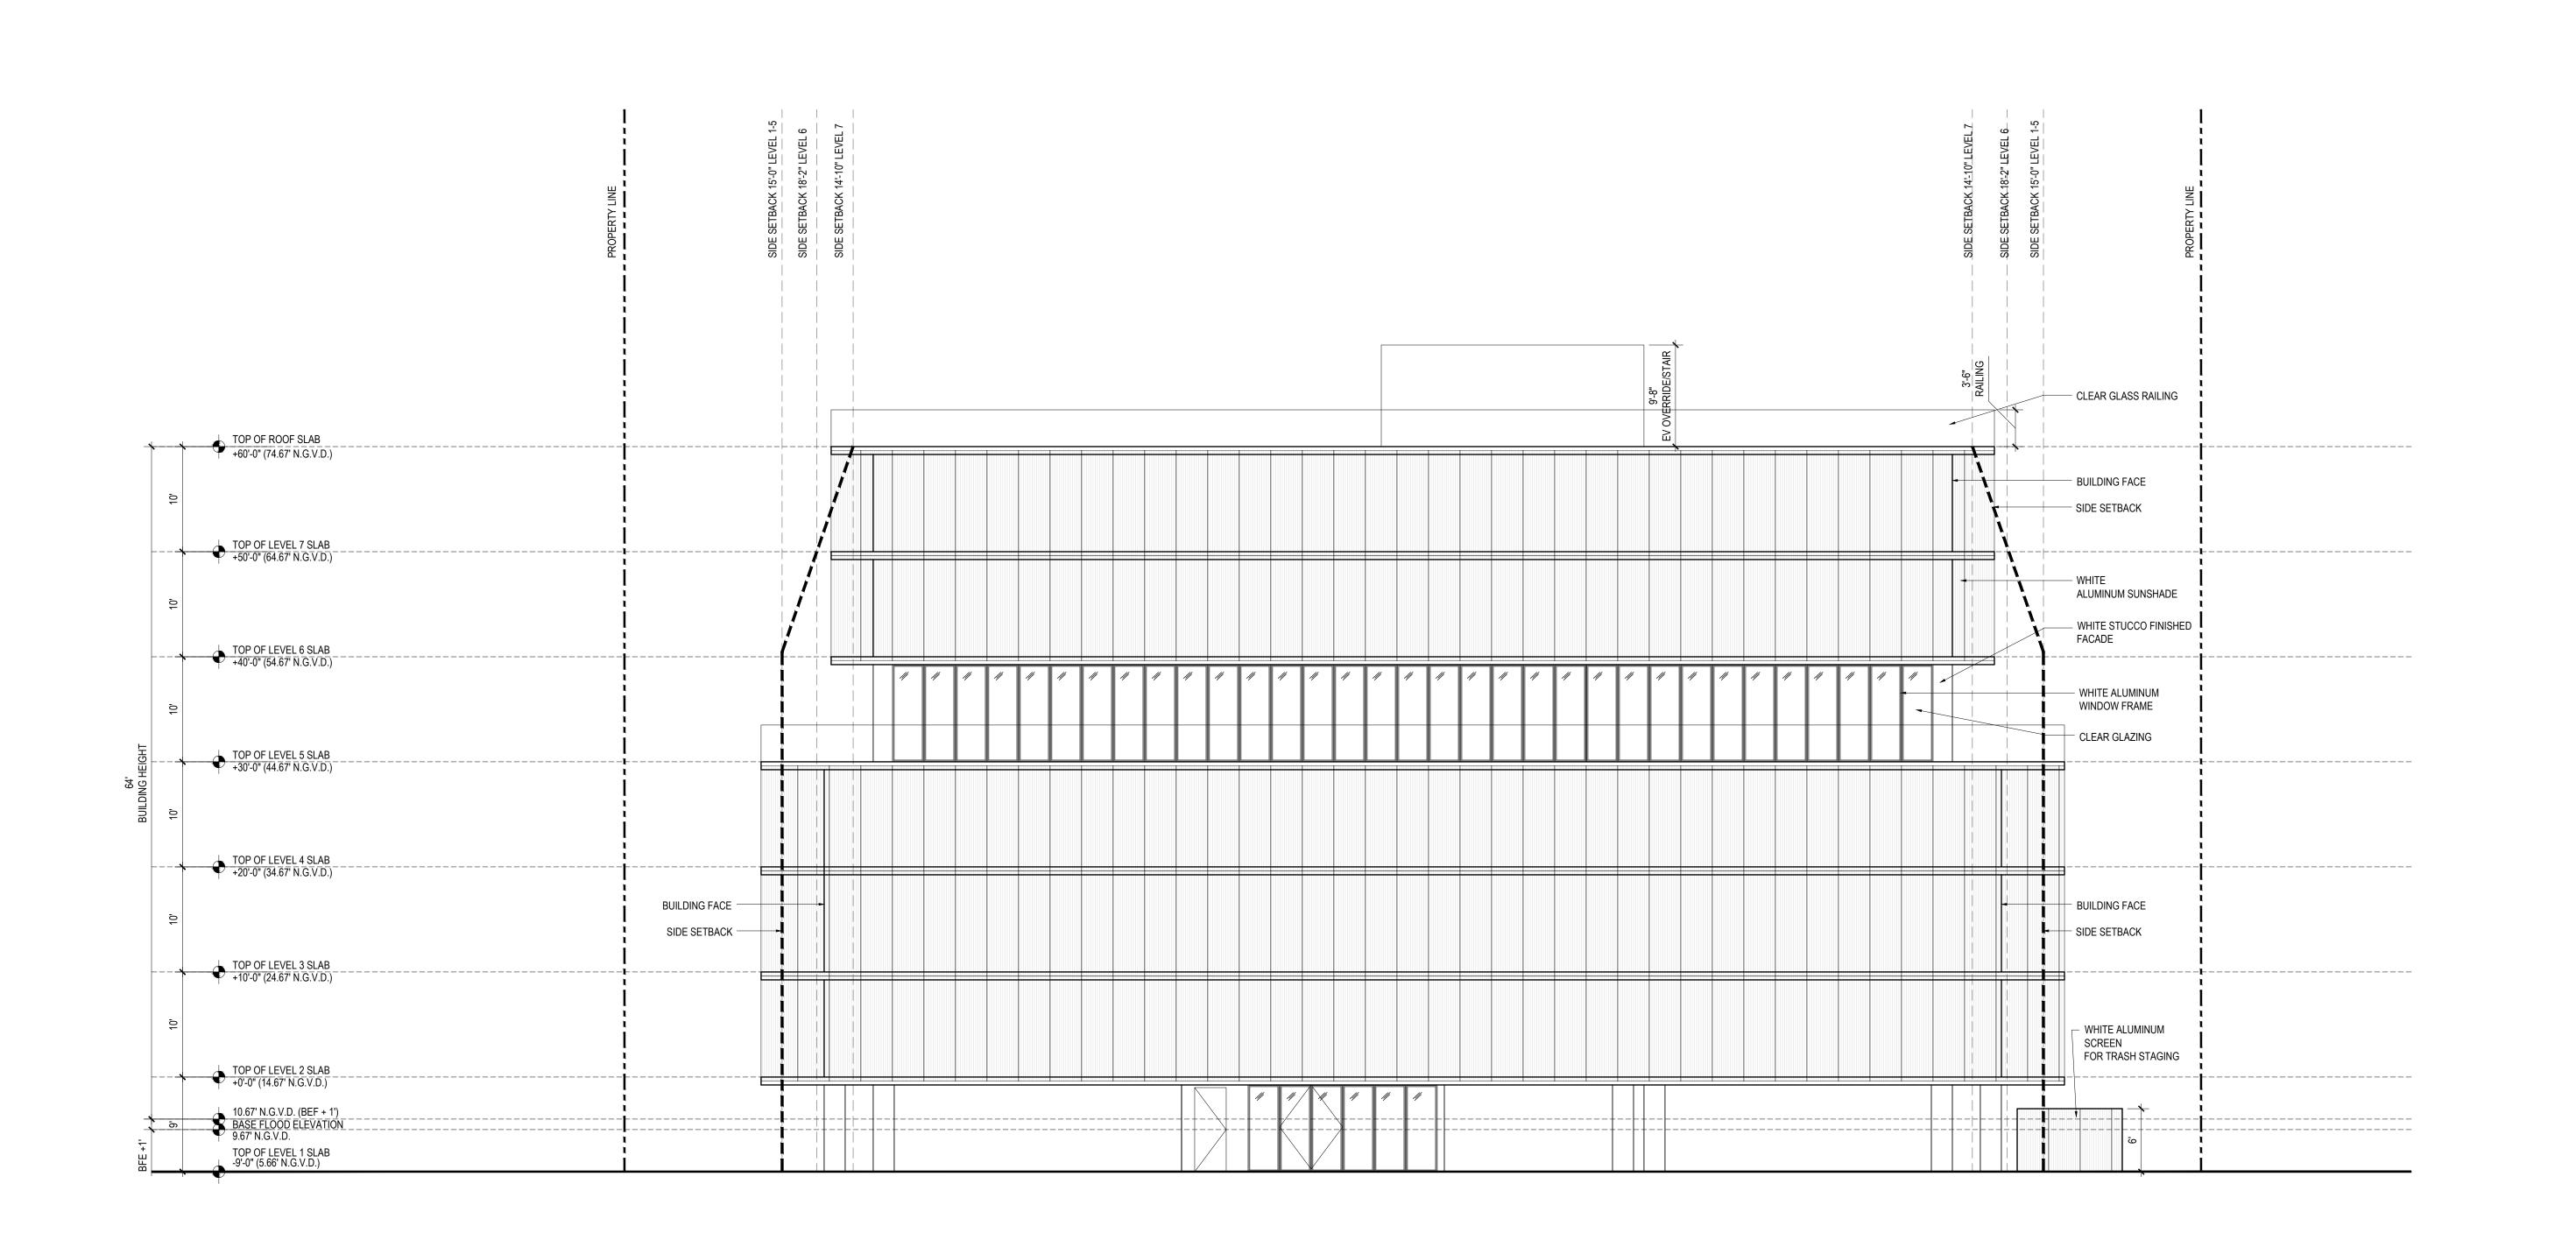


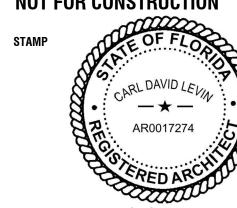**PROJECT NUMBER** 2218

TITLE ROOF FLOOR FLOOR PLAN

DRAWING NO.

ROOF FLOOR PLAN
SCALE: 1/8" = 1' - 0"



1130-1140 100TH STREET, BAY HARBOR ISLANDS, FL 33154

DEVELOPER: Redhoek + Partners

138 PIONEER STREET BROOKLYN, NY 11231 T: 718.852.8162

DESIGNER: Fab 314 architecture workshop HAYESOD STREET 2 #121 TEL AVIV-YAFO, 6816721, IL T: 972-50-888-2629

DESIGNER: Pliskin architecture Pllc 233 BROADWAY, SUITE 2030

NEW YORK, NY 10279 T: 212-899-9885

ARCHITECT: Carl Levin Architecture + Design 3390 MARY STREET, SUITE 135 COCONUT GROVE, FL 33133 T: 305 442 3118

CIVIL: Nga engineers inc. 11231 SW 88TH ST., UNIT D-114 MIAMI, FL 33176 T: 305 200 6701

LANDSCAPE: STRATA LANDSCAPE ARCHITECTURE 1906 TIGERTAIL AVE MIAMI, FL 33133

T: 305 747 9336

LIGHTING: Power & Lighting Systems, Inc. 3832 SHIPPING AVE. MIAMI, FL 33146 T: 305 444 8520


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KEY PLAN

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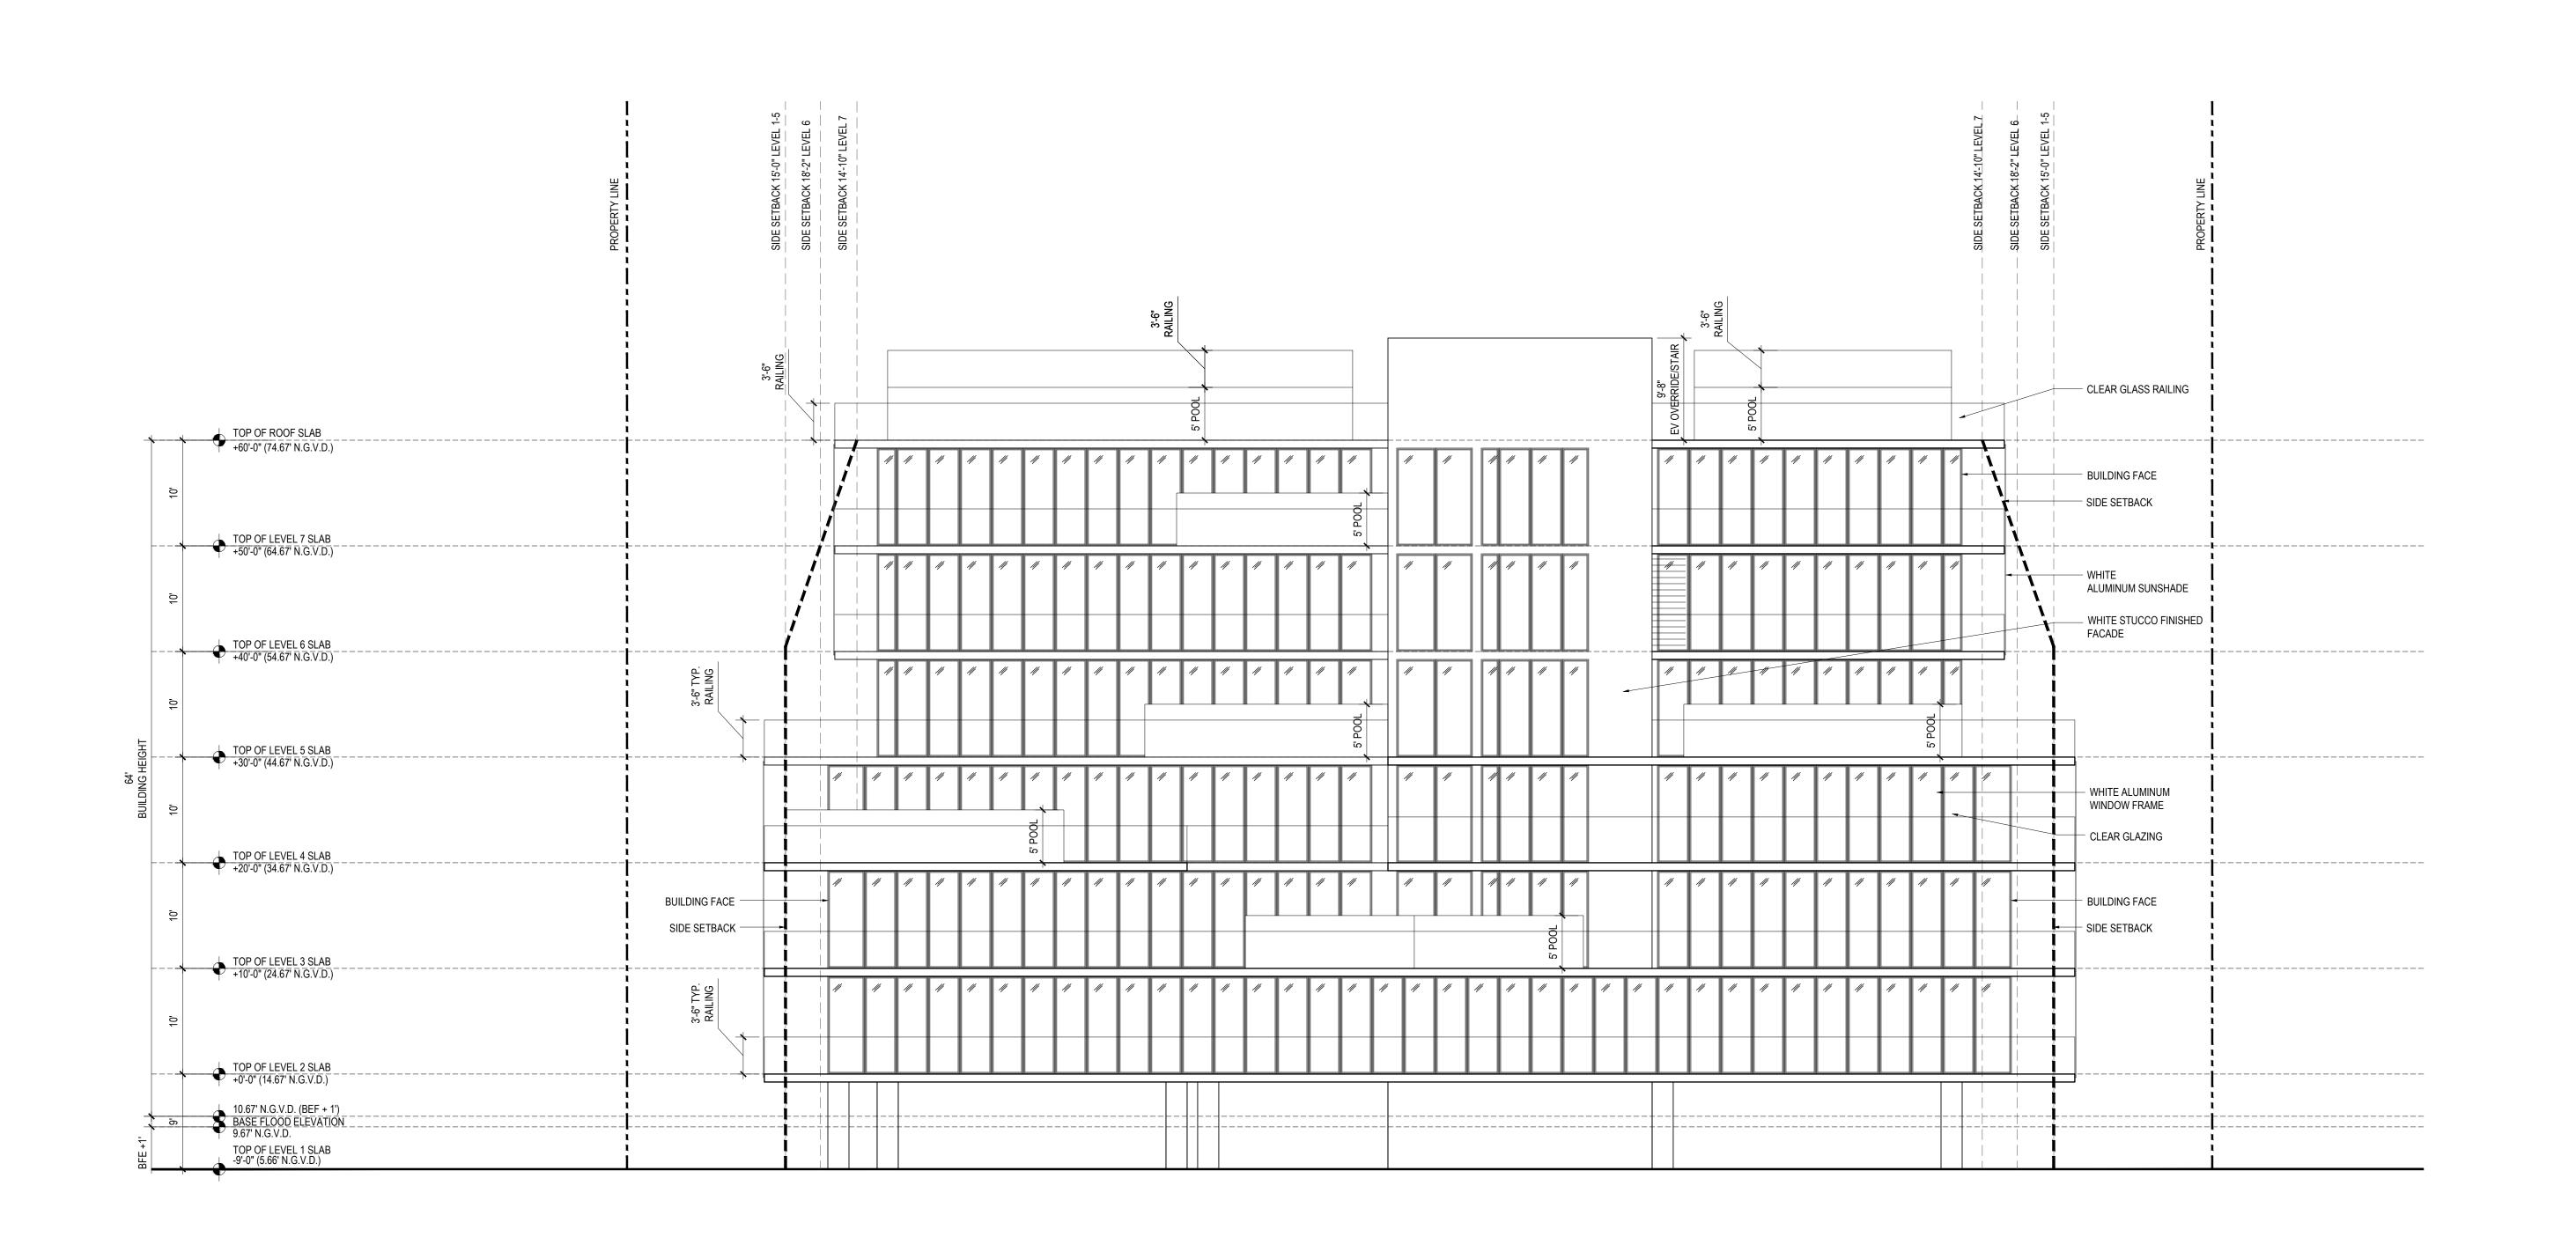
**PROJECT NUMBER** 2218

TITLE BUILDING ELEVATION NORTH

BUILDING ELEVATION - NORTH

SCALE: 1/8" =1' - 0"

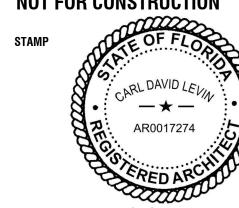DRAWING NO.



1130-1140 100TH STREET, BAY HARBOR ISLANDS, FL 33154

DEVELOPER: Redhoek + Partners

138 PIONEER STREET BROOKLYN, NY 11231 T: 718.852.8162

DESIGNER: Fab 314 architecture workshop HAYESOD STREET 2 #121 TEL AVIV-YAFO, 6816721, IL T: 972-50-888-2629

DESIGNER: Pliskin architecture Pllc 233 BROADWAY, SUITE 2030

NEW YORK, NY 10279 T: 212-899-9885

ARCHITECT: CARL LEVIN ARCHITECTURE + DESIGN 3390 MARY STREET, SUITE 135 COCONUT GROVE, FL 33133

T: 305 442 3118 CIVIL: Nga engineers inc. 11231 SW 88TH ST., UNIT D-114

MIAMI, FL 33176 T: 305 200 6701

LANDSCAPE: STRATA LANDSCAPE ARCHITECTURE 1906 TIGERTAIL AVE MIAMI, FL 33133 T: 305 747 9336

LIGHTING: Power & Lighting Systems, Inc. 3832 SHIPPING AVE. MIAMI, FL 33146 T: 305 444 8520


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KEY PLAN

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<u>01 ISSUE FOR SITE PLAN REVIEW</u> <u>12. 29. 2022</u>




**PROJECT NUMBER** 2218

TITLE BUILDING ELEVATION SOUTH

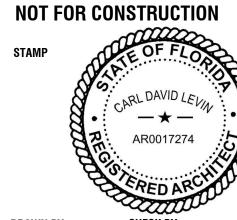BUILDING ELEVATION - SOUTH

SCALE: 1/8" =1' - 0"

DRAWING NO.

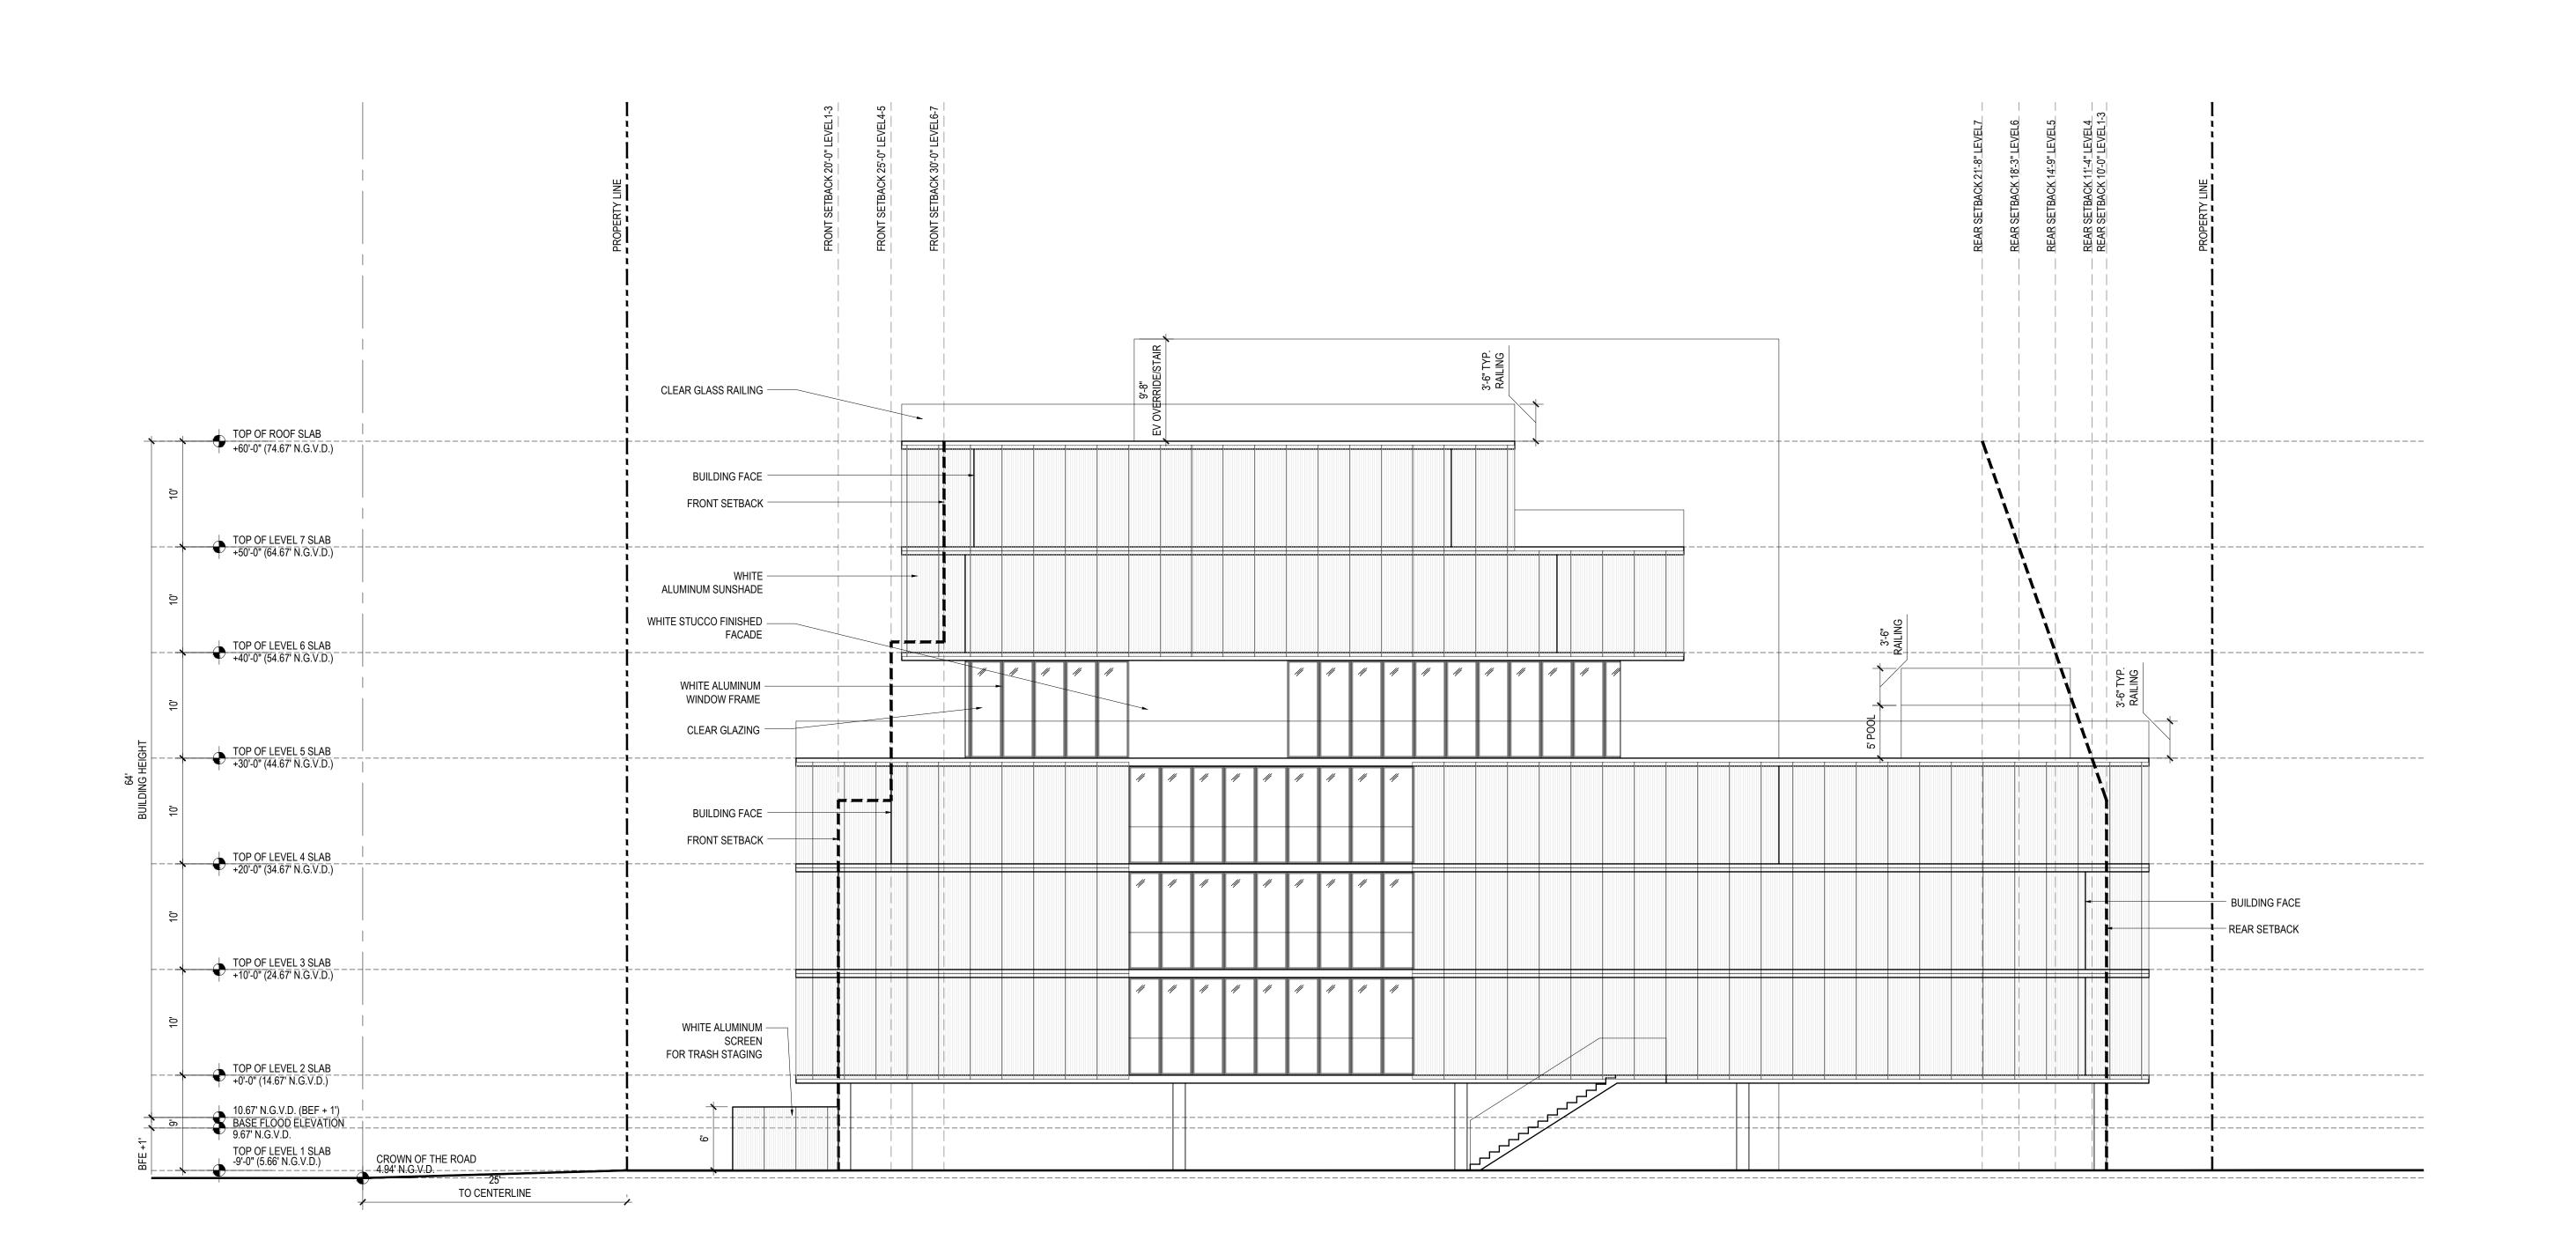

1130-1140 100TH STREET, BAY HARBOR ISLANDS, FL 33154

DEVELOPER: Redhoek + Partners

138 PIONEER STREET BROOKLYN, NY 11231 T: 718.852.8162

DESIGNER: FAB 314 ARCHITECTURE WORKSHOP HAYESOD STREET 2 #121 TEL AVIV-YAFO, 6816721, IL T: 972-50-888-2629

DESIGNER: PLISKIN ARCHITECTURE PLLC 233 BROADWAY, SUITE 2030

NEW YORK, NY 10279 T: 212-899-9885

ARCHITECT:
CARL LEVIN ARCHITECTURE + DESIGN
3390 MARY STREET, SUITE 135
COCONUT GROVE, FL 33133
T: 305 442 3118

CIVIL: Nga engineers inc.

11231 SW 88TH ST., UNIT D-114 MIAMI, FL 33176 T: 305 200 6701

LANDSCAPE: STRATA LANDSCAPE ARCHITECTURE 1906 TIGERTAIL AVE MIAMI, FL 33133 T: 305 747 9336

LIGHTING: Power & Lighting Systems, Inc. 3832 SHIPPING AVE. MIAMI, FL 33146 T: 305 444 8520

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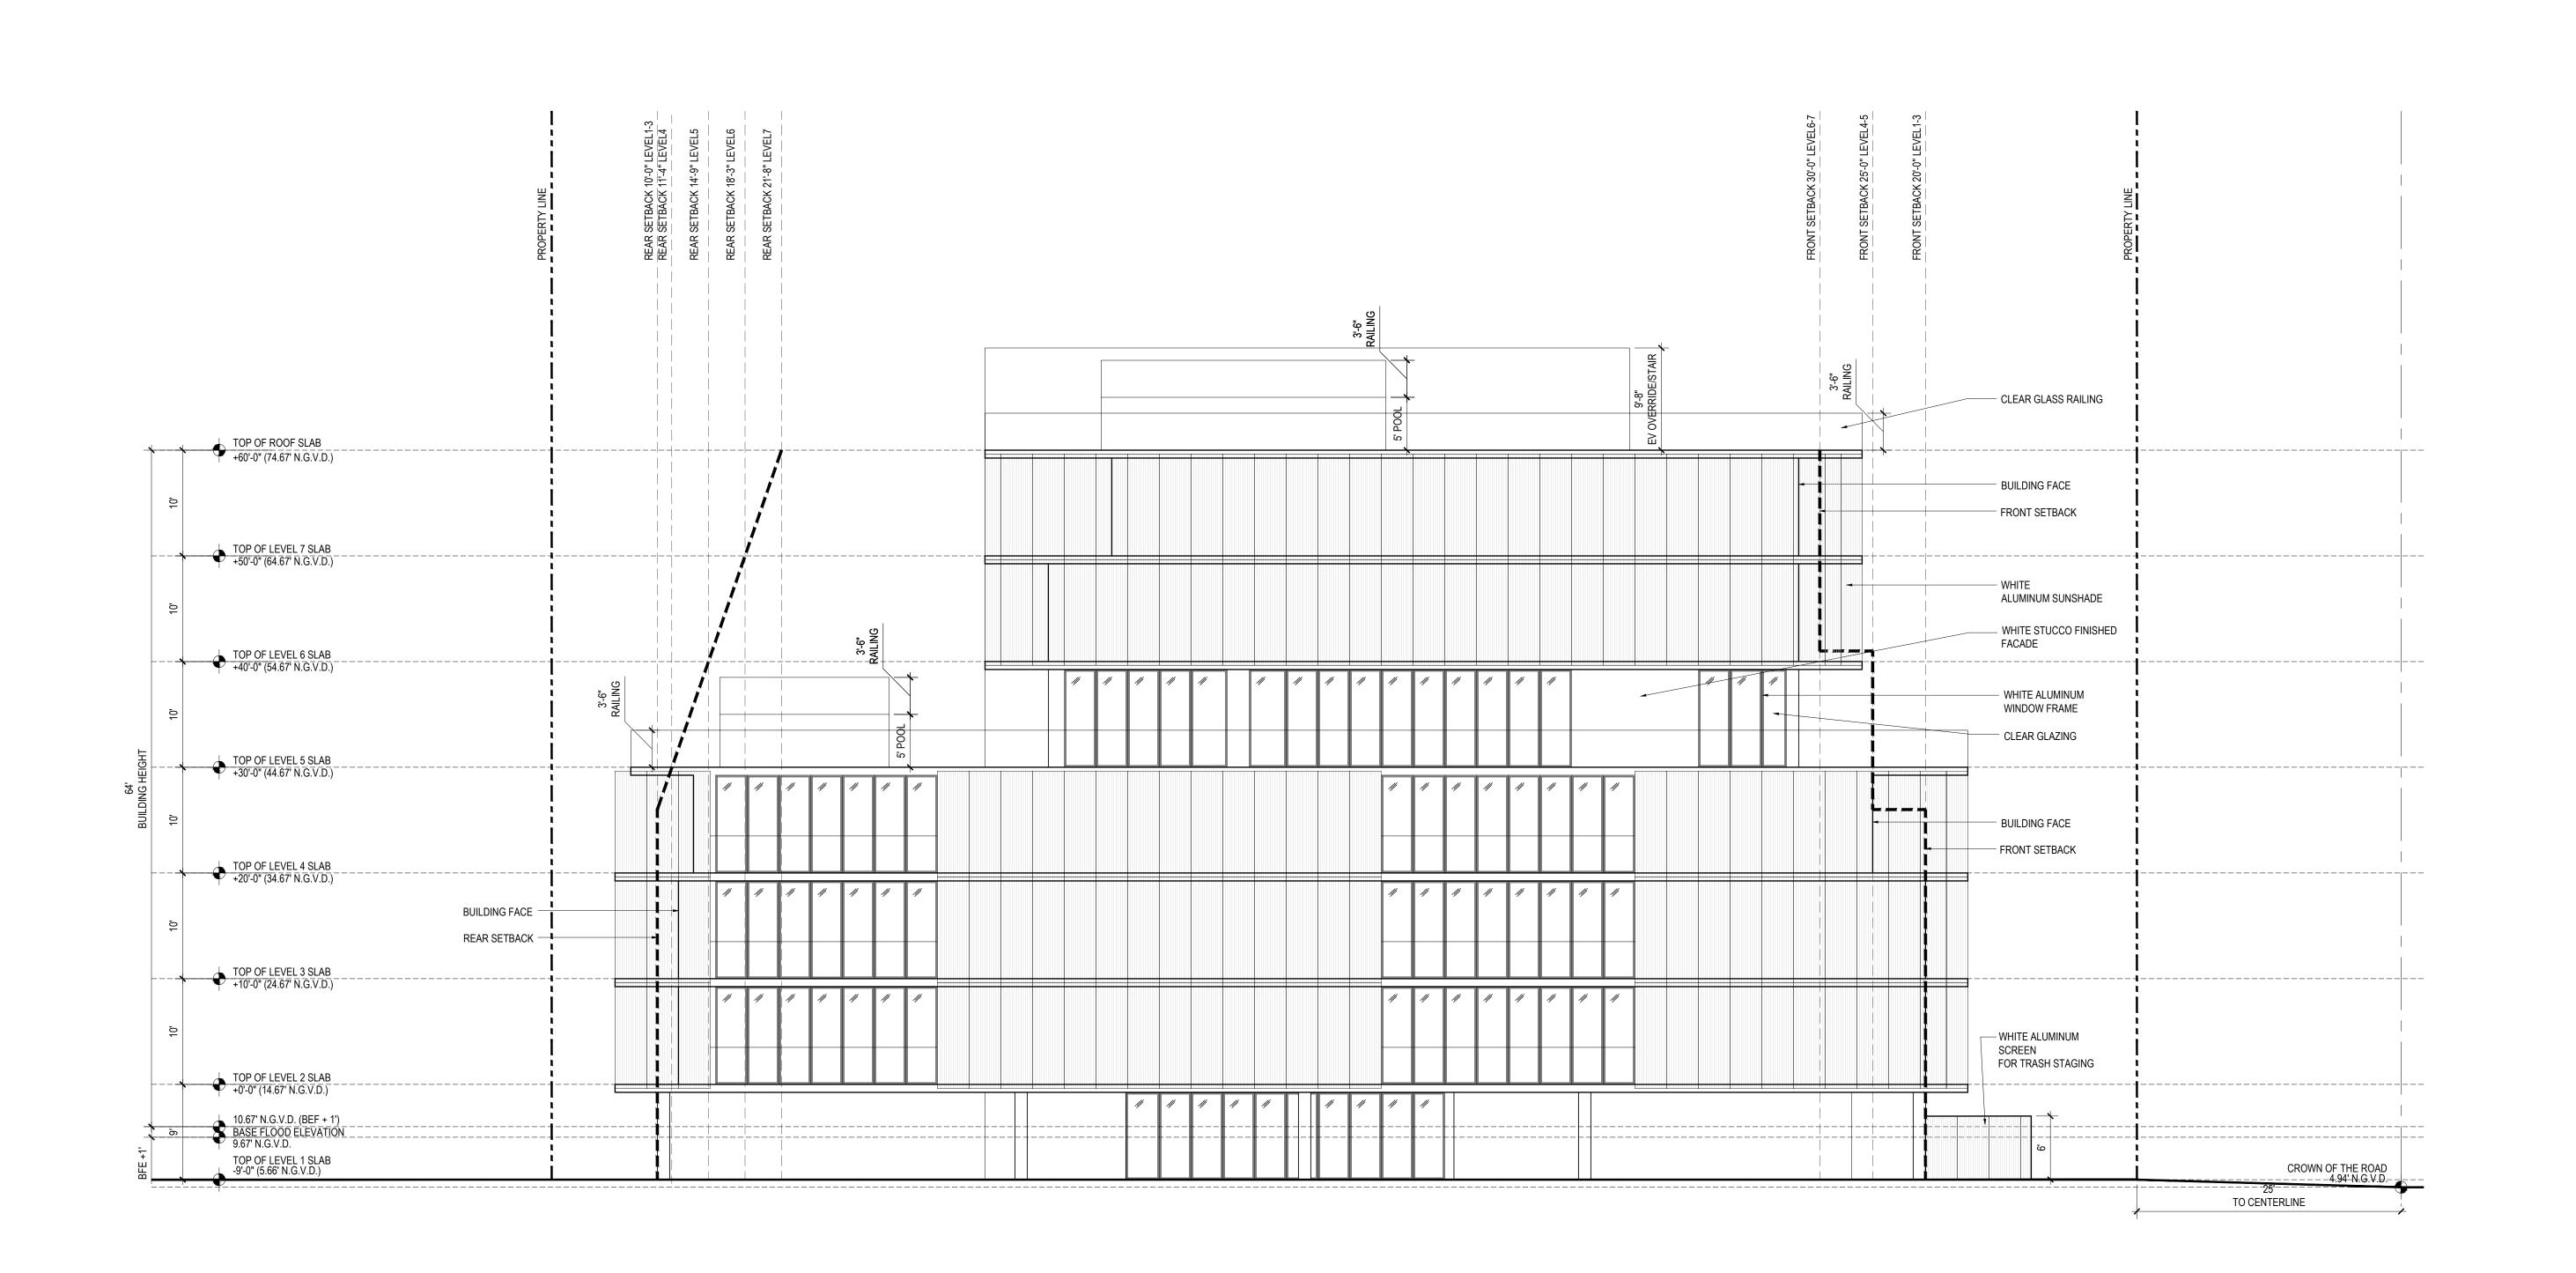
**PROJECT NUMBER** 2218

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BUILDING ELEVATION - WEST

SCALE: 1/8" =1' - 0"

DRAWING NO.



1130-1140 100TH STREET, BAY HARBOR ISLANDS, FL 33154

DEVELOPER: Redhoek + Partners

138 PIONEER STREET BROOKLYN, NY 11231 T: 718.852.8162

DESIGNER: Fab 314 architecture workshop HAYESOD STREET 2 #121 TEL AVIV-YAFO, 6816721, IL T: 972-50-888-2629

DESIGNER: Pliskin architecture Pllc 233 BROADWAY, SUITE 2030

NEW YORK, NY 10279 T: 212-899-9885

ARCHITECT:
CARL LEVIN ARCHITECTURE + DESIGN
3390 MARY STREET, SUITE 135
COCONUT GROVE, FL 33133

T: 305 442 3118 CIVIL: Nga engineers inc. 11231 SW 88TH ST., UNIT D-114

MIAMI, FL 33176 T: 305 200 6701 LANDSCAPE: STRATA LANDSCAPE ARCHITECTURE 1906 TIGERTAIL AVE MIAMI, FL 33133 T: 305 747 9336

LIGHTING: Power & Lighting Systems, Inc. 3832 SHIPPING AVE.

MIAMI, FL 33146 T: 305 444 8520

DOB APPROVAL STAMP

DOB APPROVAL SCAN

KEY PLAN

PRINTING <u>01 ISSUE FOR SITE PLAN REVIEW</u> <u>12.29.2022</u>

NOT FOR CONSTRUCTION



**PROJECT NUMBER** 2218

TITLE BUILDING ELEVATION EAST

BUILDING ELEVATION - EAST

SCALE: 1/8" =1' - 0"

DRAWING NO.


















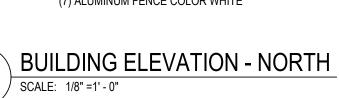

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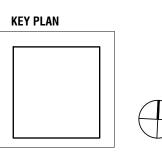
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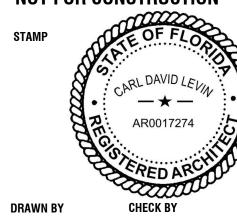
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. 01 ISSUE FOR SITE PLAN REVIEW . 12, 29, 2022

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**PROJECT NUMBER** 2218

TITLE COLORED BUILDING ELEVATION NORTH

DRAWING NO.



















BUILDING ELEVATION - SOUTH
SCALE: 1/8" = 1' - 0"

BHI 1130-1140 100TH ST

1130-1140 100TH STREET, BAY HARBOR ISLANDS, FL 33154

DEVELOPER: Redhoek + Partners

138 PIONEER STREET BROOKLYN, NY 11231 T: 718.852.8162

DESIGNER: FAB 314 ARCHITECTURE WORKSHOP HAYESOD STREET 2 #121 TEL AVIV-YAFO, 6816721, IL T: 972-50-888-2629

DESIGNER: Pliskin architecture Pllc 233 BROADWAY, SUITE 2030

NEW YORK, NY 10279 T: 212-899-9885

ARCHITECT:
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T: 305 442 3118

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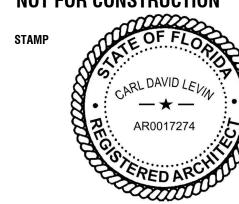
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DOB APPROVAL SCAN

**KEY PLAN** 

• 01 ISSUE FOR SITE PLAN REVIEW • 12, 29, 2022

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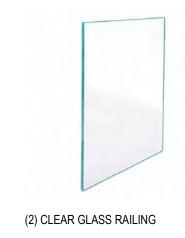
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TITLE COLORED BUILDING ELEVATION SOUTH

DRAWING NO.
















(6) ALUMINUM SCREEN COLOR WHITE



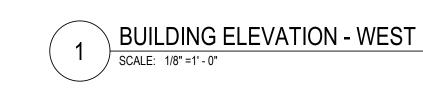

BHI 1130-1140 100TH ST

1130-1140 100TH STREET, BAY HARBOR ISLANDS, FL 33154

DEVELOPER: Redhoek + Partners

138 PIONEER STREET BROOKLYN, NY 11231 T: 718.852.8162

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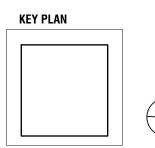
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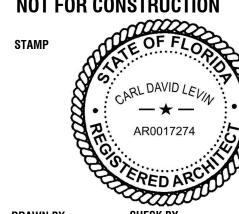
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DOB APPROVAL SCAN



. 01 ISSUE FOR SITE PLAN REVIEW . 12, 29, 2022

NOT FOR CONSTRUCTION



**PROJECT NUMBER** 2218

TITLE COLORED BUILDING ELEVATION WEST

DRAWING NO.



















1130-1140 100TH STREET, BAY HARBOR ISLANDS, FL 33154

### DEVELOPER: Redhoek + Partners

138 PIONEER STREET BROOKLYN, NY 11231 T: 718.852.8162

DESIGNER: FAB 314 ARCHITECTURE WORKSHOP HAYESOD STREET 2 #121 TEL AVIV-YAFO, 6816721, IL T: 972-50-888-2629

## DESIGNER: PLISKIN ARCHITECTURE PLLC 233 BROADWAY, SUITE 2030

NEW YORK, NY 10279 T: 212-899-9885

ARCHITECT:
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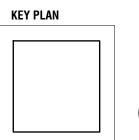
# CIVIL: NGA ENGINEERS INC. 11231 SW 88TH ST., UNIT D-114 MIAMI, FL 33176 T: 305 200 6701

# LANDSCAPE: STRATA LANDSCAPE ARCHITECTURE 1906 TIGERTAIL AVE MIAMI, FL 33133 T: 305 747 9336

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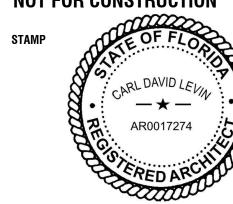
#### DOB APPROVAL STAMP

DOB APPROVAL SCAN



. 01 ISSUE FOR SITE PLAN REVIEW . 12, 29, 2022

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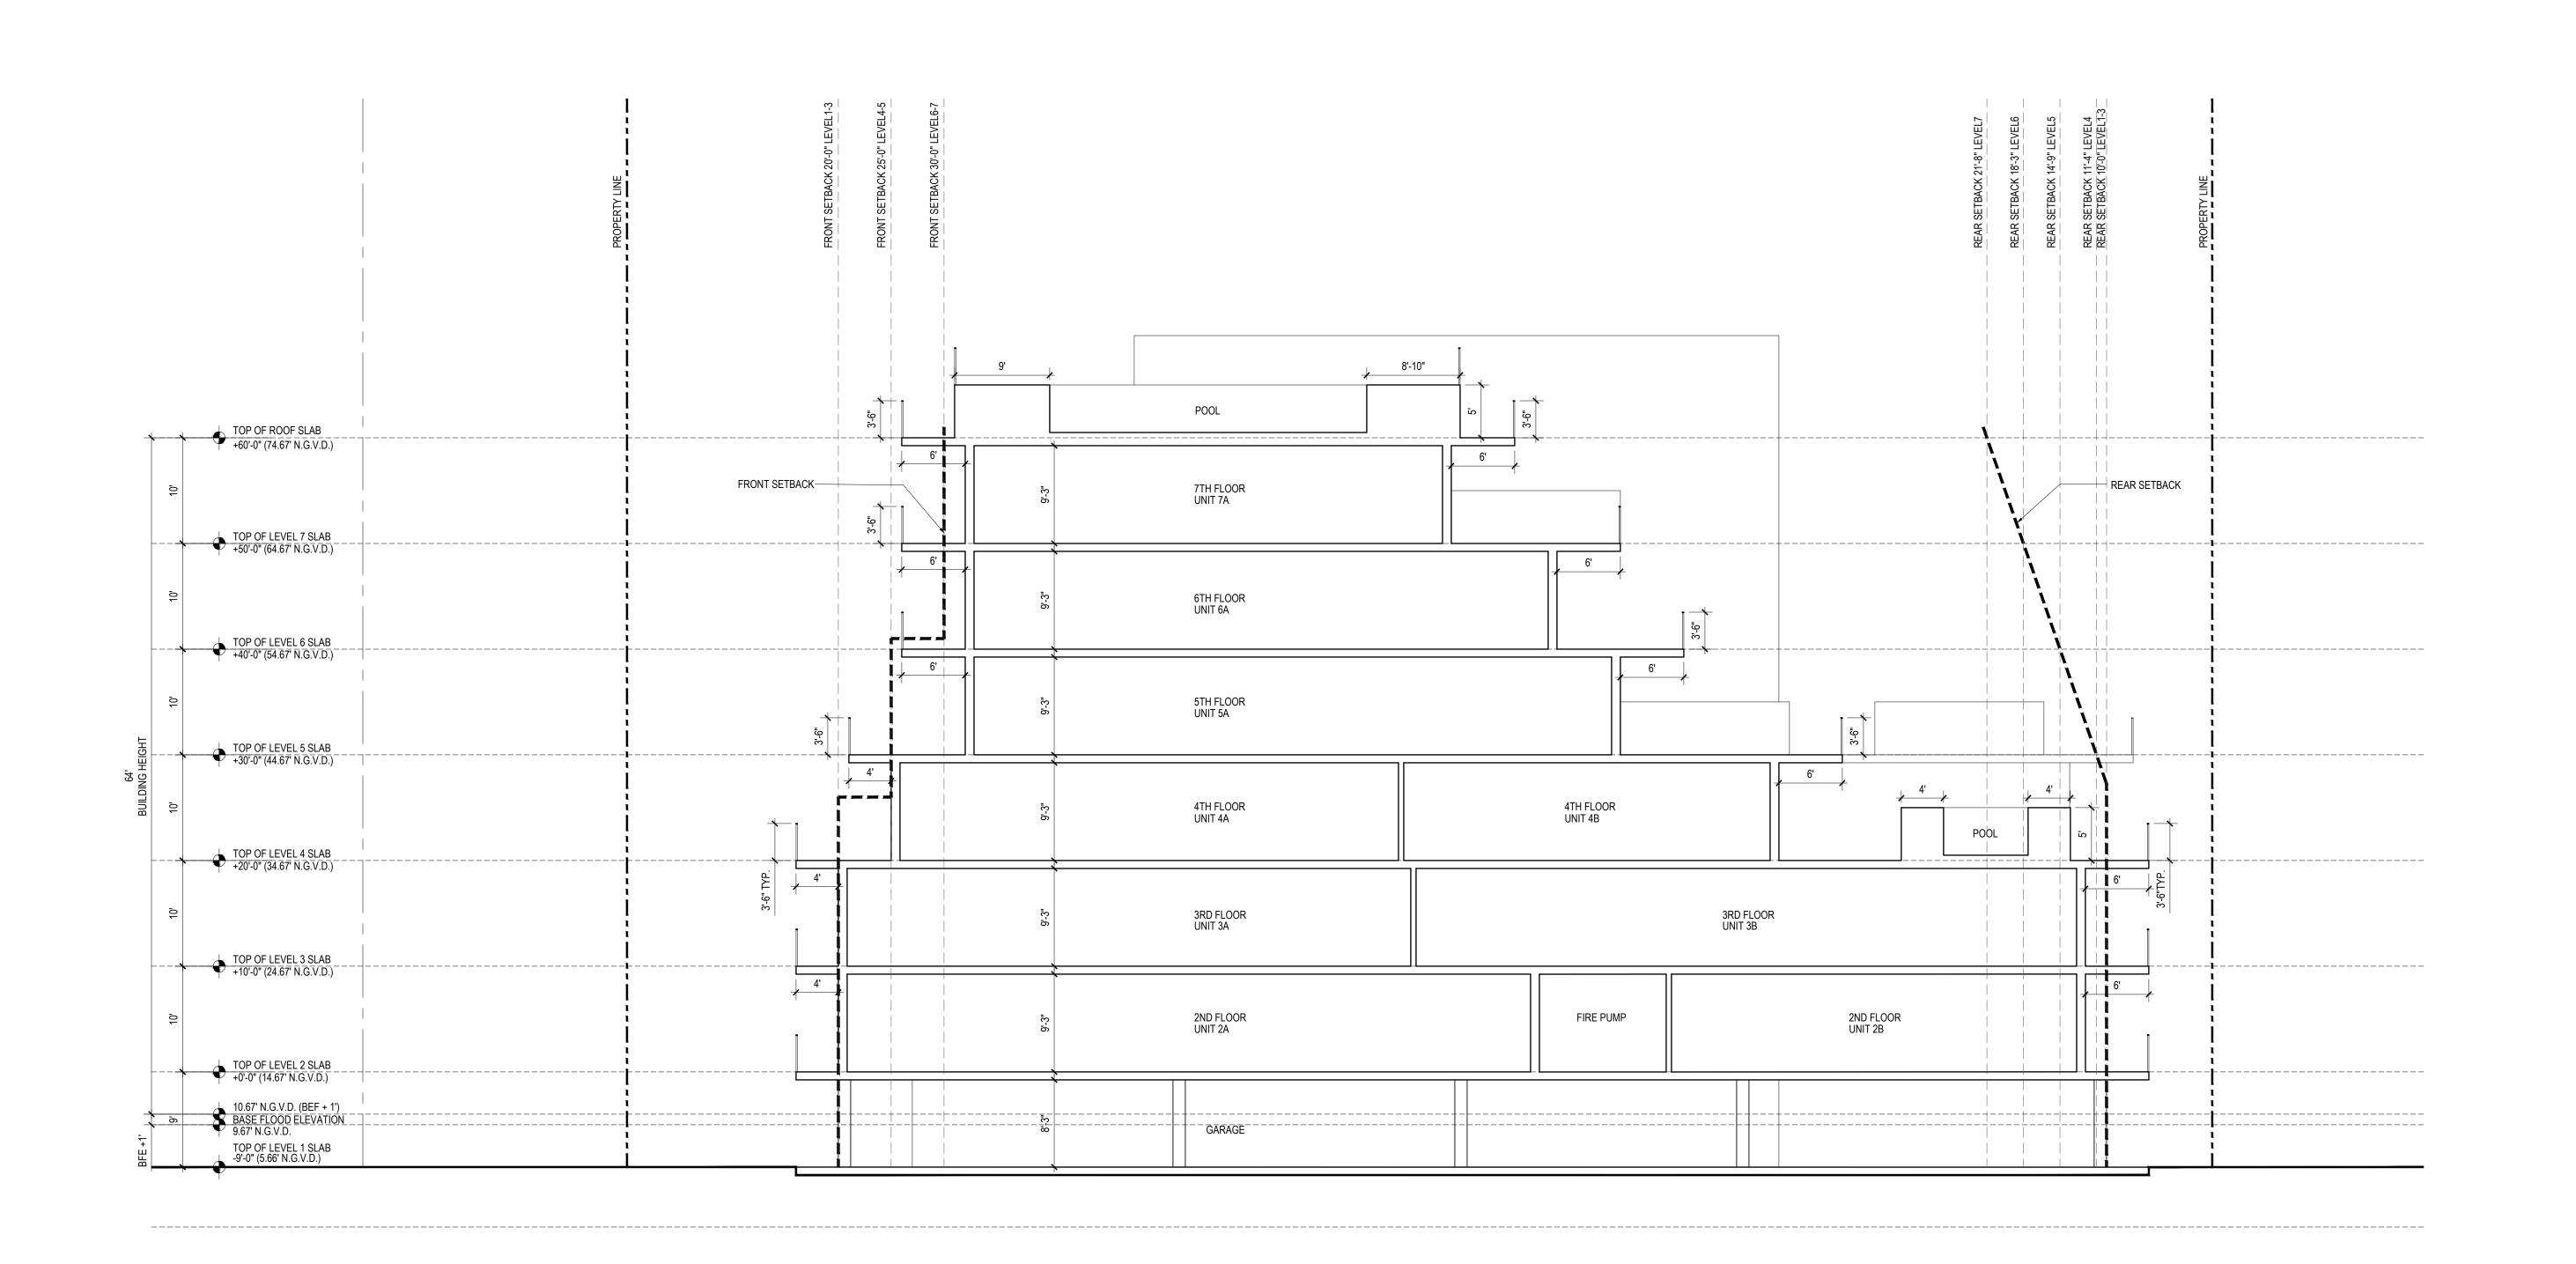


## **PROJECT NUMBER** 2218

TITLE

COLORED BUILDING ELEVATION EAST

DRAWING NO.



1130-1140 100TH STREET, BAY HARBOR ISLANDS, FL 33154

DEVELOPER: Redhoek + Partners

138 PIONEER STREET BROOKLYN, NY 11231 T: 718.852.8162

DESIGNER: FAB 314 ARCHITECTURE WORKSHOP HAYESOD STREET 2 #121 TEL AVIV-YAFO, 6816721, IL T: 972-50-888-2629

DESIGNER: PLISKIN ARCHITECTURE PLLC 233 BROADWAY, SUITE 2030

NEW YORK, NY 10279 T: 212-899-9885

ARCHITECT:
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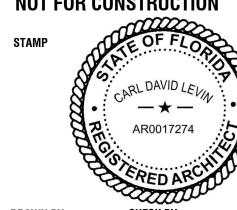
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DOB APPROVAL SCAN

**KEY PLAN** 

. 01 ISSUE FOR SITE PLAN REVIEW . 12. 29. 2022

NOT FOR CONSTRUCTION



**PROJECT NUMBER** 2218

TITLE BUILDING ELEVATION SOUTH & NORTH

DRAWING NO.

BUILDING SECTION

SCALE: 1/8" = 1' - 0"

#### INDEX OF SHEETS

- PD-1 COVER SHEET
- PD-2 PAVING GRADING & DRAINAGE PLANS & TYPICAL SECTIONS
- PD-3 DRAINAGE & PAVEMENT DETAILS

#### **DEMOLITION NOTES:**

1.- UNLESS OTHERWISE NOTED, ALL EXISTING IMPROVEMENTS WITHIN THE LIMITS OF WORK SHALL BE REMOVED IN THEIR ENTIRETY.

2.- ASPHALT PAVEMENT DESIGNATED FOR DEMOLITION SHALL BE REMOVED AND DISPOSED OF OFF-SITE AT AN APPROVED LOCATION. SAW-CUT ALL PAVEMENT EDGES WHERE EXISTING PAVEMENT IS TO REMAIN.

3.- IN GREEN AREAS, EXISTING LIMEROCK SUBBASE SHALL BE SCARIFIED TO ITS FULL DEPTH AND SHAPED TO THE LINES AND GRADES SHOWN IN THESE DRAWINGS 4.- ALL EXISTING DRAINAGE IMPROVEMENTS WITHIN THE LIMITS OF WORK, IF ANY, SHALL BE REMOVED, INCLUDING STRUCTURES, PIPES, AND FRENCH DRAINS.

#### TRENCH SAFETY ACT

CONTRACTOR SHALL COMPLY WITH THE REQUIREMENTS OF THE "TRENCH SAFETY ACT" AND ALL REQUIREMENTS OF O.S.H.A.

#### SITE DATA

FLOOD ZONE FIRM MAP PANEL No. = 12086C0144L ZONE "AE" DATED: 09-11-2009 BASE FLOOD ELEVATIONS = 9.0 NGVD & 8.0 NGVD WATER TABLE ELEVATION OCT. H.W. = (+) 2.0 NGVD FLOOD CRITERIA ELEVATION = (+) 5.00 NGVD


#### **UNDERGROUND DIGGING NOTE:**

CONTRACTOR SHALL USE EXTREME CAUTION WHEN EXCAVATING CONTRACTOR SHALL REMAIN 2 FEET AWAY FROM THE LOCATED MARKS WITH THE MACHINERY. IF IT'S NECESSARY TO EXCAVATE WITHIN THE 2 FOOT TOLERANCE ZONE, CONTRACTOR MUST HAND DIG, SOFT DIG, OR USE NON-INVASIVE MEANS TO EXPOSE AND PROTECT THE EXISTING FACILITIES AS REQUIRED BY LAW.

#### **GENERAL NOTES:**

- 1. VERTICAL CONTROL POINTS AND ALL ELEVATIONS ARE BASED ON 1929 NGVD DATUM.
- 2. THE CONTRACTOR SHALL CONFIRM ALL HORIZONTAL AND VERTICAL CONTROL POINTS PRIOR TO USE. THE CONTRACTOR SHALL CONFIRM ALIGNMENT AND ELEVATIONS OF ADJACENT WORK PRIOR TO BEGINNING CONSTRUCTION. ALL DISCREPANCIES SHALL BE IMMEDIATELY BROUGHT TO THE OWNER'S
- 3. ALL EXISTING UTILITIES SHALL REMAIN IN SERVICE, UNLESS OTHERWISE NOTED.
- 4. USE EXTREME CAUTION NEAR ALL UTILITIES, CABLES, CONDUITS, AND MANHOLES. CONTRACTOR TO PROVIDE PROTECTION DURING CONSTRUCTION TO ASSURE SERVICE AT ALL TIMES. CONTRACTOR SHALL COORDINATE ALL SCHEDULES WITH FIELD REPRESENTATIVE PRIOR TO WORKING AROUND UTILITIES.
- 5. CONTRACTOR SHALL BE RESPONSIBLE FOR BECOMING FAMILIAR WITH CURRENT SITE CONDITIONS AND SHALL REPORT ANY DISCREPANCIES ON THE PLANS TO THE ENGINEER PRIOR TO COMMENCING WORK.
- 6. ALL CONSTRUCTION LAYOUT SHALL BE THE RESPONSIBILITY OF THE CONTRACTOR. THE CONTRACTOR SHALL BE RESPONSIBLE FOR ESTABLISHING THE WORK LIMIT LINES AS SHOWN ON THE PLANS AND SHALL WORK WITHIN THE LIMITS AND DIMENSIONS SHOWN. ALL PAVEMENT DIMENSIONS ARE TO THE EDGE OF PAVEMENT. ANY DEVIATION FROM THE PLANS SHALL REQUIRE WRITTEN APPROVAL FROM THE ENGINEER PRIOR TO EXECUTING WORK.
- GRADING SHALL CONSIST OF ALL EXCAVATION, BACKFILLING, SHAPING AND SLOPING NECESSARY FOR THE CONSTRUCTION, PREPARATION AND COMPLETION OF ALL WORK AND OTHER AREAS, ALL IN ACCORDANCE WITH THE LAYOUT AND GRADES SHOWN ON THESE DRAWINGS. SAWCUT ALL PAVEMENT EDGES WHERE EXISTING PAVEMENT IS TO REMAIN.
- 8. Contractor shall be responsible for protecting and restoring all adjacent IMPROVEMENTS. CONTRACTOR SHALL BE RESPONSIBLE FOR RESETTING ALL DISTURBED EXISTING MANHOLE COVERS, VALVE BOXES, BLOW-OFF RISERS, ETC. TO NEW ELEVATIONS, AS REQUIRED, WHETHER SPECIFICALLY SHOWN ON DRAWINGS OR NOT.
- 9. THE CONTRACTOR SHALL NOTIFY ALL UTILITY COMPANIES THAT MAY BE AFFECTED BY THE PROPOSED WORK, PRIOR TO THE START OF ANY CONSTRUCTION, TO ARRANGE FOR PHYSICAL LOCATION AND ELEVATION OF ALL UNDERGROUND IMPROVEMENTS. IT IS THE CONTRACTOR'S RESPONSIBILITY TO PROVIDE THE UTILITY COMPANY SUFFICIENT NOTICE TO SCHEDULE ANY RELOCATION OF THEIR UTILITIES. THE CONTRACTOR SHALL BE RESPONSIBLE FOR SUPPORT OF ANY UTILITY THAT MAY BE IN CONFLICT WITH OR ENDANGERED BY THE PROPOSED WORK.
- 10. ALL OVERHEAD OR SURFACE STRUCTURES AND UTILITIES ENCOUNTERED ARE TO BE CAREFULLY PROTECTED FROM DAMAGE OR DISPLACEMENT. ALL DAMAGE TO SUCH STRUCTURES SHALL BE COMPLETELY REPAIRED WITHIN THE TIME FRAME OF THE CONSTRUCTION. THE OWNER RESERVES THE RIGHT TO REMEDY SUCH DAMAGE BY ORDERING OUTSIDE PARTIES TO MAKE SUCH REPAIRS AT THE EXPENSE OF THE CONTRACTOR.
- 11. THE CONTRACTOR MAY STORE EQUIPMENT AND MATERIALS WITHIN THE LIMITS OF THE SITE. THE CONTRACTOR SHALL MAINTAIN THESE AREAS IN A CLEAN AND ORDERLY CONDITION SO AS NOT TO CAUSE A NUISANCE IN THE AREA. THE CONTRACTOR SHALL RESTORE THE STORAGE AREA TO ITS ORIGINAL OR BETTER CONDITION, WITH ALL ITS APPURTENANCES, IN KIND, TO THE SATISFACTION OF THE ENGINEER AND OWNER.
- 12. COMPLETE "AS-BUILT" INFORMATION RELATIVE TO LOCATION, SIZE AND DEPTH OF THE PROPOSED PIPES, STRUCTURES, AND OTHER IMPROVEMENTS SHALL BE ACCURATELY RECORDED. THIS INFORMATION SHALL BE SUBMITTED TO THE ENGINEER AS A CADD FILE AND AS A DRAWING SIGNED AND SEALED BY A PROFESSIONAL LAND SURVEYOR REGISTERED IN THE STATE OF FLORIDA AT THE CONTRACTOR'S EXPENSE.
- 13. THE UNDERGROUND UTILITIES SHOWN HEREON ARE BASED ON EXISTING UTILITY PLANS. NO SUBSURFACE VERIFICATION OF THE UTILITIES WAS MADE. SOME UTILITIES MAY NOT BE REFLECTED IN THESE PLANS. BEFORE EXCAVATION OR CONSTRUCTION, CONTACT THE SUNSHINE ONE CALL SERVICE #811 AND THE APPROPRIATE UTILITY COMPANIES FOR FIELD VERIFICATION. SUBSURFACE CASINGS, DUCT BANKS, FOOTINGS FOUNDATIONS, AND OTHER SUBSURFACE FEATURES ARE NOT LOCATED OR SHOWN HEREON ARE TO BE VERIFIED BY CONTRACTOR BEFORE COMMENCING ANY WORK.
- 14. PROVIDE 6 FOOT VINYL VISUAL BARRIER ON ALL FENCING AT CONSTRUCTION LIMITS.
- 15. THE CONTRACTOR SHALL BE RESPONSIBLE FOR MAINTAINING THE INTEGRITY AND MAKING THE REPAIRS OF EXISTING PAVEMENT, SIDEWALKS, PIPES, CONDUITS, CURBS, CABLES, ETC., WHETHER OR NOT SHOWN ON THE PLANS, DAMAGED AS A RESULT OF THE CONTRACTOR'S OPERATIONS AND/OR THOSE OF HIS SUBCONTRACTORS, AND SHALL RESTORE THEM PROMPTLY TO THE ORIGINAL CONDITIONS OR BETTER AT NO ADDITIONAL EXPENSE TO THE OWNER. CONTRACTOR SHALL REPORT ANY DAMAGED SIDEWALK, DRIVEWAY, ETC., PRIOR TO BEGINNING WORK IN ANY AREA.
- 16. EXISTING WATER METERS, UTILITY POLES & GUY WIRES AND OTHER UTILITIES WITHIN THE LIMITS OF CONSTRUCTION SHALL BE REMOVED OR RELOCATED UNLESS OTHERWISE NOTED.
- 17. ALL WORK SHALL CONFORM TO ALL APPLICABLE CODES, ORDINANCES OF TOWN OF BAY HARBOR STANDARDS AND DETAILS, MIAMI-DADE COUNTY STANDARDS AND DETAILS, MIAMI-DADE COUNTY DEPARTMENT OF ENVIRONMENTAL RESOURCES (DERM) STANDARDS AND DETAILS AND FLORIDA DEPARTMENT OF TRANSPORTATION STANDARDS AND DETAILS.



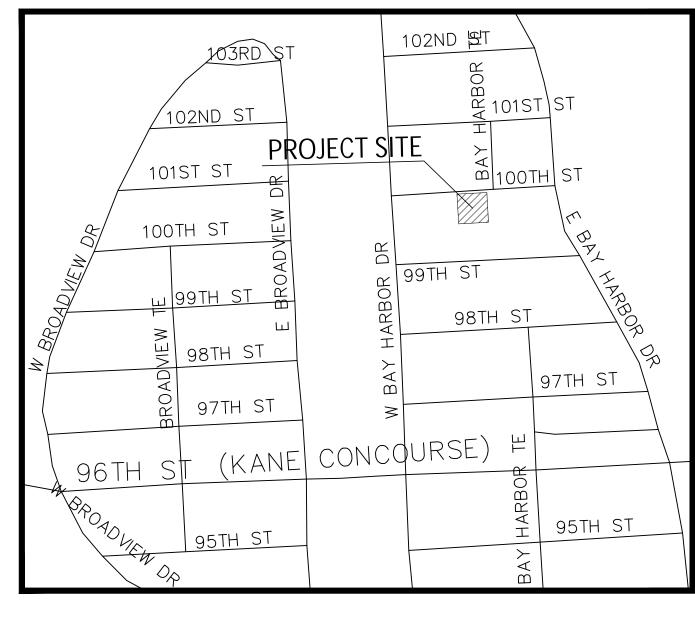

**LOCATION MAP** SCALE 1" = 300'

LEGAL DESCRIPTION

LOTS 5 & 6, BLOCK 8, OF BAY HARBOR ISLAND, ACCORDING TO THE PLAT THEREOF, AS RECORDED IN PLAT BOOK 46 PAGE 5 OF THE PUBLIC RECORDS OF MIAMI-DADE COUNTY, FLORIDA

REDHOEK + PARTNERS 138 PIONEER STREET BROOKLYN, NY 11231 T: 718.852.8162 DESIGNER: FAB 314 ARCHITECTURE WORKSHOP HAYESOD STREET 2 #121

BHI 1130-1140 100TH ST 1130-1140 100TH STREET

BAY HARBOR ISLANDS, FL 33154

TEL AVIV-YAFO, 6816721, IL T: 972-50-888-2629

DEVELOPER:

PLISKIN ARCHITECTURE PLLC 233 BROADWAY, SUITE 2030 NEW YORK, NY 10279 T: 212-899-9885 ARCHITECT:

CARL LEVIN ARCHITECTURE + DESIGN 3390 MARY STREET, SUITE 135 COCONUT GROVE, FL 33133 T: 305 442 3118

NGA ENGINEERS INC. 11231 SW 88TH ST., UNIT D-114 MIAMI, FL 33176

T: 305 200 6701

LANDSCAPE: STRATA LANDSCAPE ARCHITECTURE 1906 TIGERTAIL AVE MIAMI, FL 33133 T: 305 747 9336


LIGHTING: POWER & LIGHTING SYSTEMS, INC. 3832 SHIPPING AVE. MIAMI, FL 33146 T: 305 444 8520

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DOB APPROVAL SCAN




Civil Engineers 11231 SW 88th St., Unit D-114, Miami, FL. 33176. TEL: (305) 200 6701 EMAIL: nobel@ngaengineers.com

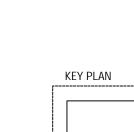

01 ISSUE FOR SITE PLAN REVIEW 12. 29. 2022

NOT FOR CONSTRUCTION

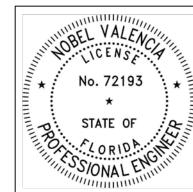

THIS ITEM HAS BEEN DIGITALLY SIGNED AND SEALED BY NOBEL VALENCIA, P.E., ON THE DATE ADJACENT TO THE PRINTED COPIES OF THIS DOCUMENT ARE NOT CONSIDERED SIGNED AND SEALED AND THE SIGNATURE MUST BE VERIFIED ON ANY ELECTRONIC COPIES. 12/18/2022

#### **ENGINEER'S CERTIFICATION:**



I HEREBY CERTIFY: That this plan was prepared under my direction and to the best of my knowledge and belief complies with the intent of the "MANUAL OF UNIFORM Call 811 or visit sunshine811.com two full STANDARDS FOR DESIGN, CONSTRUCTION AND MAINTENANCE FOR STREETS, AND HIGHWAYS", as adopted Check positive response codes before you dig! by the State of Florida Legislature, Chapter 72-328 F.S.

Consultant STAMP

> DRAWN BY CHECK BY

Nobel Valencia, PE No. 72193 A.B.C. Civil Engineer PROJECT NUMBER

TITLE


Cover Sheet

DRAWING NO.

2218

PD-1

PAGE No. \_ 1 \_ 0F \_ 3

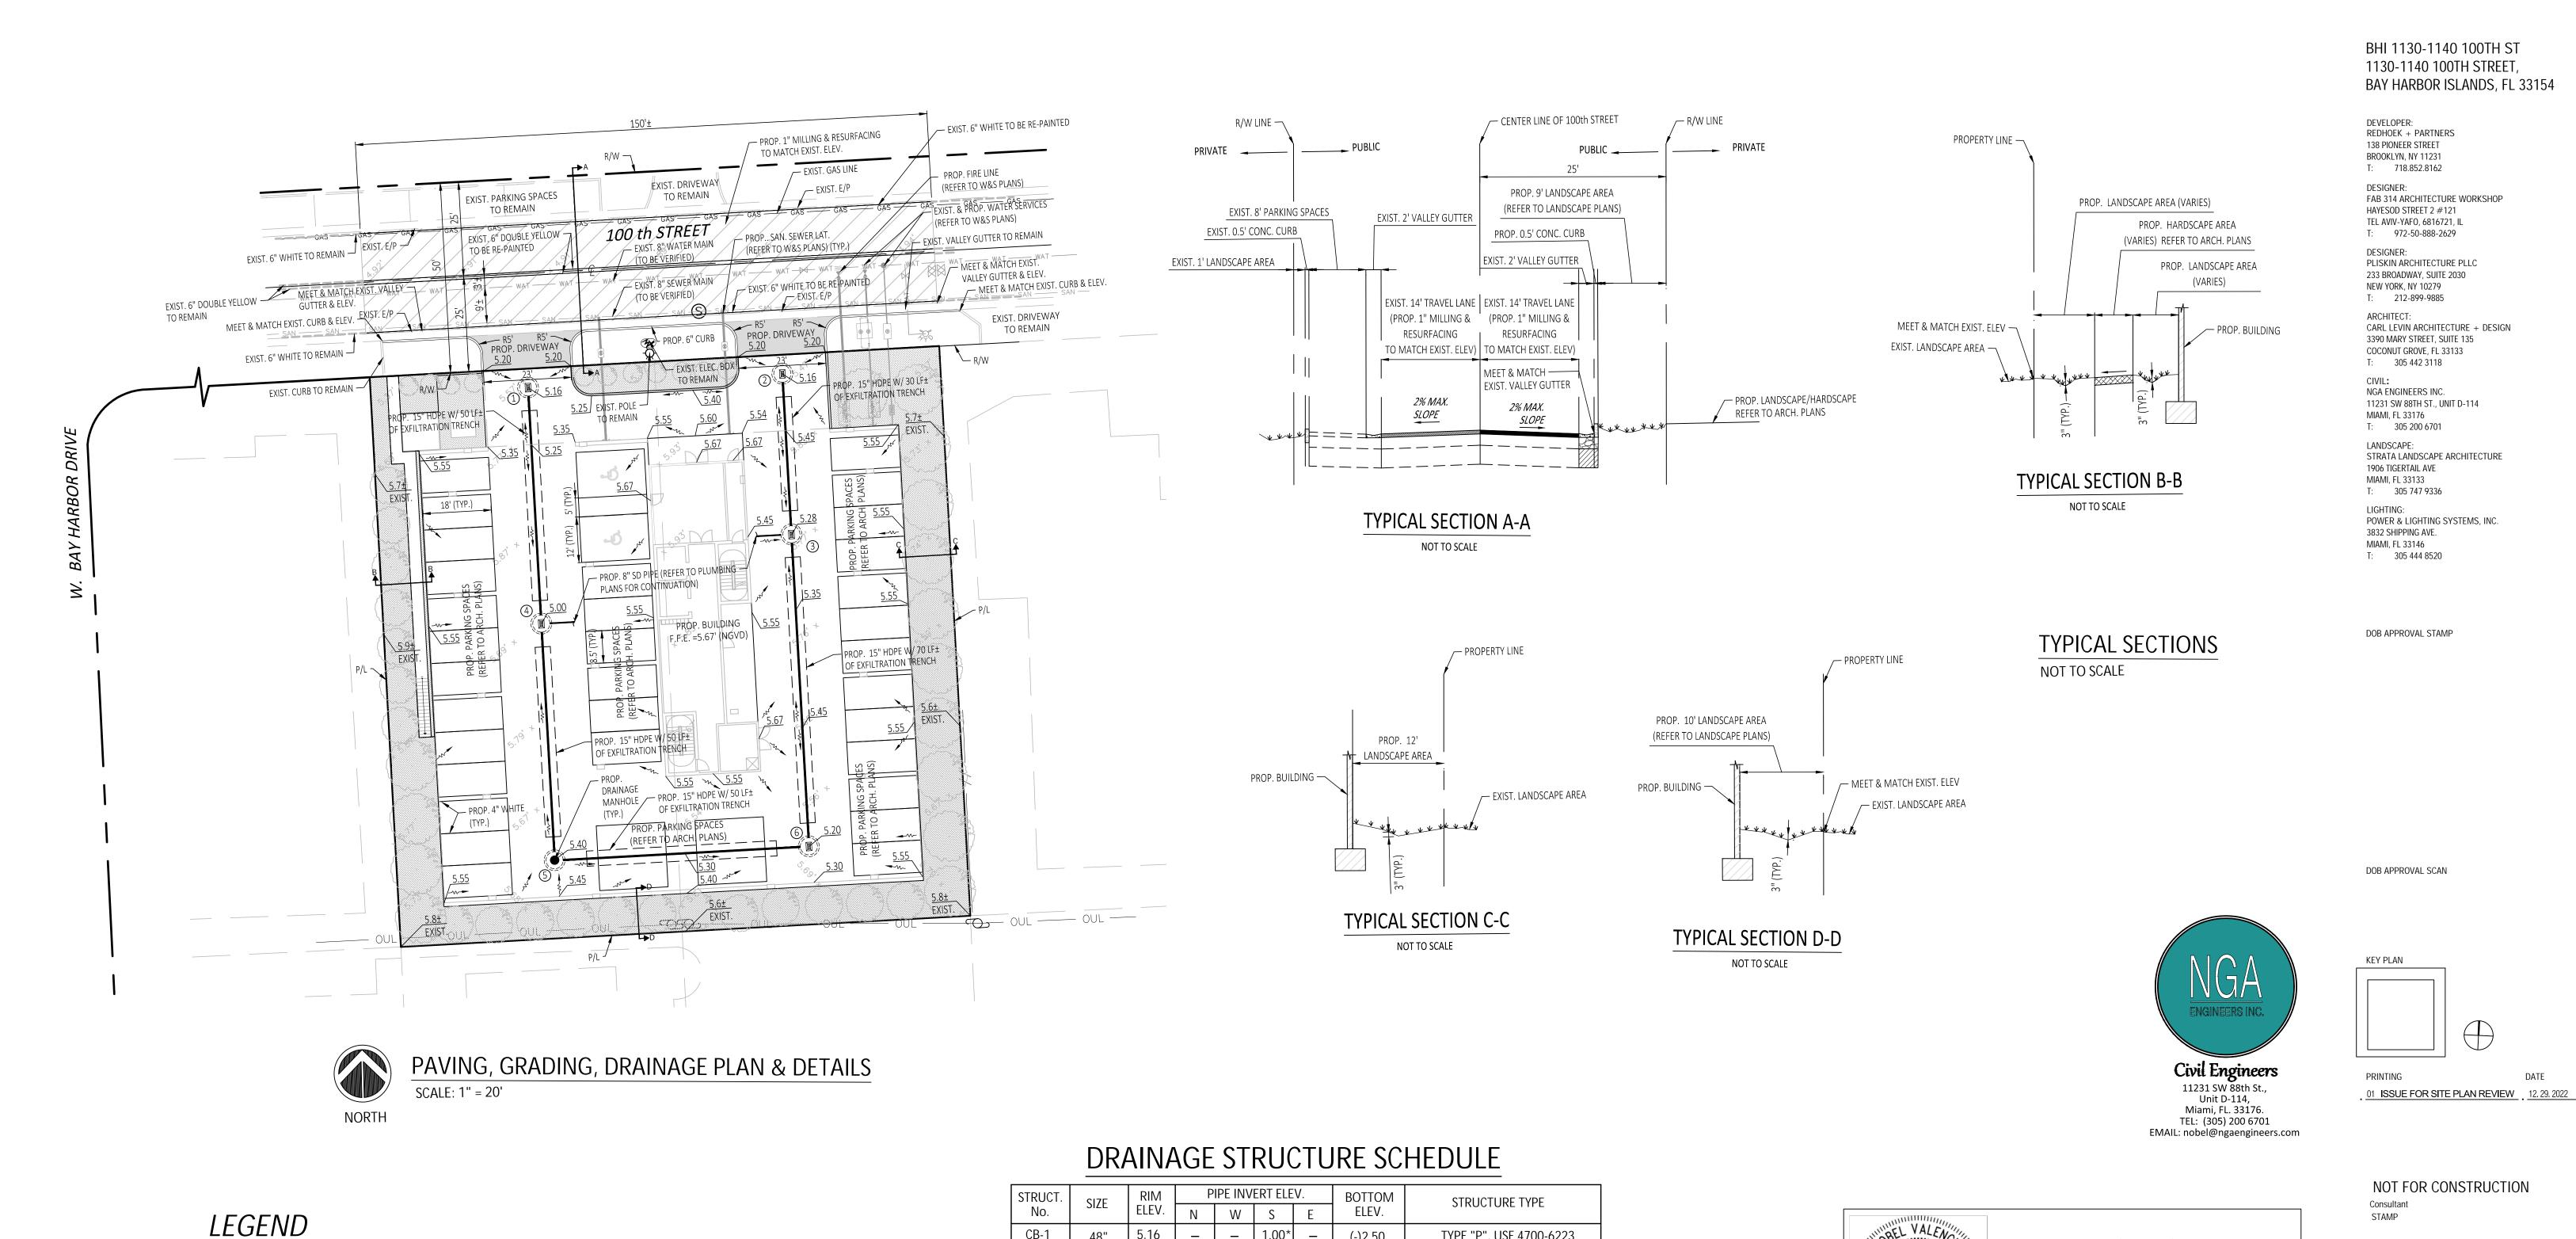

STRUCT.	TRUCT. No. SIZE RIM ELEV. N W S E BOTTOM ELEV. STRU		PIPE INVERT ELEV.			V.	воттом	STRUCTURE TYPE
No.		STRUCTURE THE						
CB-1	48"	5.16	ı	-	1.00*	_	(-)2.50	TYPE "P", USF 4700-6223
CB-2	48"	5.16	ı	1	1.00*	-	(-)2.50	TYPE "P", USF 4700-6223
CB-3	48"	5.28	1.00*	1.50	1.00*	-	(-)2.50	TYPE "P", USF 4700-6223
CB-4	48"	5.00	1.00*	-	1.00*	1.50	(-)2.50	TYPE "P", USF 4700-6223
MH-5	48"	5.40	1.00*	-	-	1.00*	(-)2.50	TYPE "P", USF 310
CB-6	48"	5.20	1.00*	1.00*	_	_	(-)2.50	TYPE "P", USF 4700-6223

\* BAFFLE REQUIRED

PROPOSED ELEVATION (NGVD)

EXISTING ELEVATION (NGVD)

PROPOSED STRUCTURE NUMBER

DIRECTION OF FLOW

PROPOSED CATCH BASIN

PROP. ASPHALT PAVEMENT

PROP. 1" MILLING & RESURFACING

PROPOSED FRENCH DRAIN

PROP. CONCRETE PAVEMENT

# STATE OF 12/18/2022

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ENGINEER'S CERTIFICATION:



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CHECK BY DRAWN BY Nobel Valencia, PE No. 72193 A.B.C. Civil Engineer

PROJECT NUMBER


Paving, Grading, Drainage Plans & **Typical Sections** 

DRAWING NO.

PD-2

#### SITE DATA

FLOOD ZONE FIRM MAP PANEL No. = 12086C0144L ZONE "AE" DATED: 09-11-2009 BASE FLOOD ELEVATION = 9.0 NGVD & 8.0 NGVD WATER TABLE ELEVATION OCT. H.W. = (+) 2.0 NGVD FLOOD CRITERIA ELEVATION = (+) 5.00 NGVD

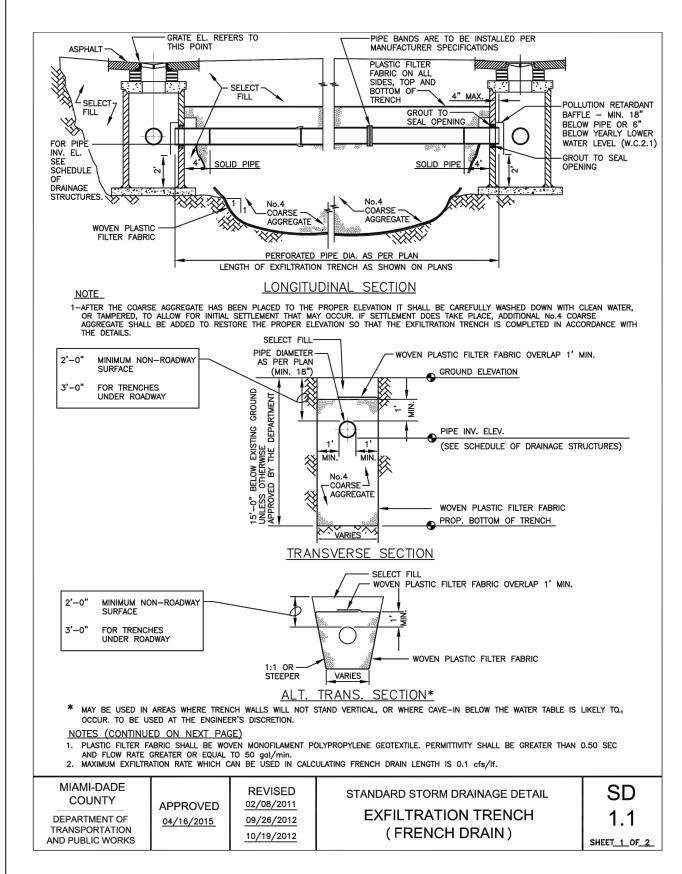

Skimmer Baffle-

TYPE I SKIMMER

— Bolt Angles To Basin Wall

Flat Wall

TOP VIEW SCHEMATIC

With (4)  $\frac{1}{2}$ "Ø x  $2\frac{1}{2}$ "

The backs of skimmers must conform to the shape of the basin walls on which they are mounted.

Show, in the plans, the radii required for curved-back skimmers. Applies to both skimmer types.

SS Expansion Anchors

SIDE ELEVATION

─ Outlet Opening ✓

TOP VIEW

in Basin Wall-

— 4 @ ¾"Ø Bolt,

Hex Nut and Washer-

LID DETAILS

Pipe -

Neoprene

— Weld Angles At

All Points Of

Contact With

11/01/17

— See Angle Detail

ANGLE DETAIL

skimmer are mirror image.

SIDE ELEVATION

extend  $\frac{1}{2}$  inch beyond the joint on all sides.

steel, 945 for aluminum or 948 for plastics.

Retrofit skimmers shall be paid for as 'modify existing structure'.

or riveted nylon strap.

Angles on other side of

TYPE I SKIMMER

DIMENSION TABLE

OUTLET PIPE


Limits Of Skimmer On

Round Wall Basin

FY 2018-19

STANDARD PLANS

FRONT ELEVATION

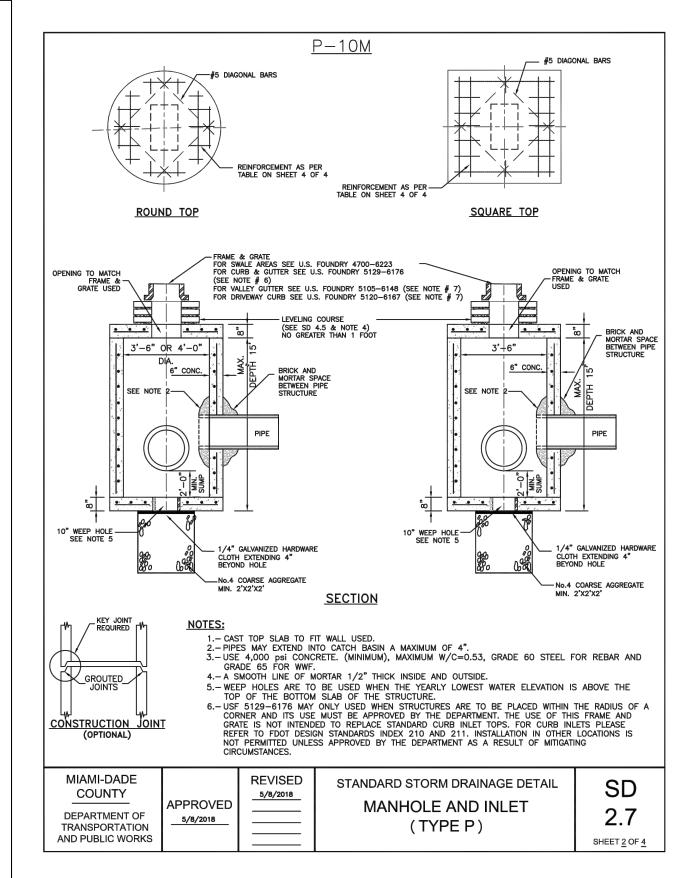

w/Nuts and Washers

- 1'-0" c to c

- 15". 18" & 24" Dia. Pipe

Flange (3" Min.)

INDEX

443-002 1 of 1

SHEET

3'-0"

FRONT ELEVATION

stainless steel quick-release latches.

TYPE II SKIMMER

debris or other floating contaminants from exiting Catchbasins through outlet pipes.

7. Plastic Skimmers shall contain a minimum of 1.5% by weight of carbon black for UV protection.

4. Type II Skimmers are to be used only with outlet pipe diameters of 15", 18", and 24".

SKIMMERS FOR FRENCH DRAIN OUTLETS

3. Type I Skimmer dimensions shall be based on the outlet pipe diameter as shown in the dimension table.

GENERAL NOTES

1. The Frenchdrain Skimmer is a hooded cover, mounted over an outlet in a catchbasin, that prevents oil and floating debris from

exiting the basin. Use this skimmer in Frenchdrain Catchbasins and in other locations where there is a need to prevent oil,

2. Place neoprene gasket material between the skimmer and the catchbasin at all points of contact. Trim the gasket neatly to

3. Skimmer baffle, cleanout pipe and angles shall be primarily constructed of either galvanized steel, aluminum, polyvinyl chloride,

4. Mounting hardware, hinges and latches shall all be stainless steel. Loss prevention device shall be either stainless steel chain

5. Material used in construction of skimmer bodies (baffles) and cleanout pipe shall comply with Standard Specification 943 for

6. All costs for furnishing and installing a frenchdrain skimmer shall be included in the cost of the basin in which it is installed.

DESIGN NOTES


2. Show, in the plans, the location of the basin and indicate the interior side(s) of the basin on which a skimmer will be installed.


1. The contractor may submit an alternative design prefabricated Frenchdrain Skimmer for approval by the Engineer.

polyethylene, fiberglass or acrylonitrite butadiene styrene. All steel components, other than stainless, shall be hot-dip

Note: The cleanout port for the Type II skimmer shall be gasketed,

with either a threaded screw-in lid or a lid secured by four

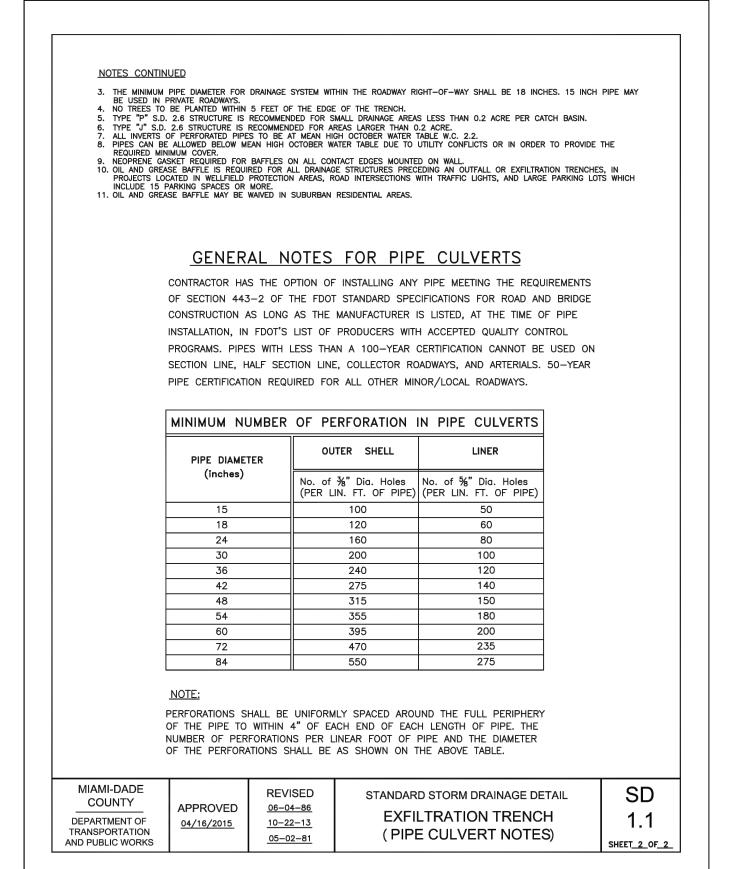

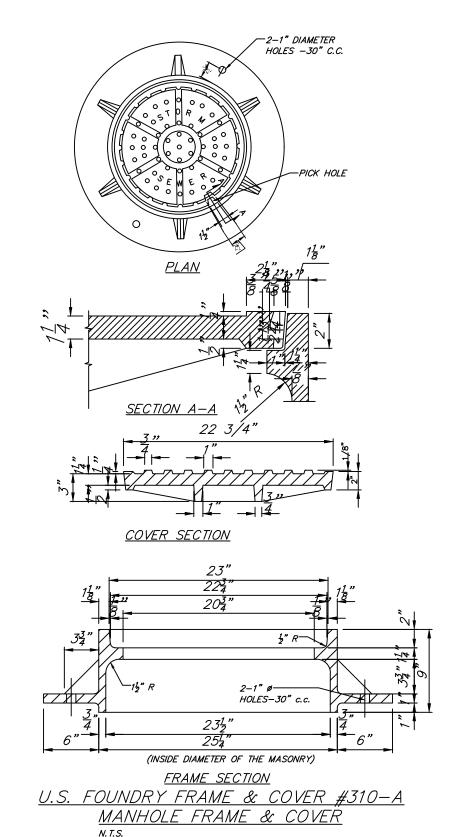

BHI 1130-1140 100TH ST 1130-1140 100TH STREET BAY HARBOR ISLANDS, FL 33154

DEVELOPER: REDHOEK + PARTNERS 138 PIONEER STREET BROOKLYN, NY 11231 T: 718.852.8162

DESIGNER: FAB 314 ARCHITECTURE WORKSHOP HAYESOD STREET 2 #121 TEL AVIV-YAFO, 6816721, IL T: 972-50-888-2629

DESIGNER: PLISKIN ARCHITECTURE PLLC 233 BROADWAY, SUITE 2030 NEW YORK, NY 10279 T: 212-899-9885

ARCHITECT: CARL LEVIN ARCHITECTURE + DESIGN 3390 MARY STREET, SUITE 135 COCONUT GROVE, FL 33133

T: 305 442 3118 NGA ENGINEERS INC. 11231 SW 88TH ST., UNIT D-114

MIAMI, FL 33176

T: 305 200 6701

T: 305 747 9336

LANDSCAPE: STRATA LANDSCAPE ARCHITECTURE 1906 TIGERTAIL AVE MIAMI, FL 33133

LIGHTING: POWER & LIGHTING SYSTEMS, INC. 3832 SHIPPING AVE. MIAMI, FL 33146 T: 305 444 8520

DOB APPROVAL STAMP

DOB APPROVAL SCAN



Civil Engineers

11231 SW 88th St., Unit D-114, Miami, FL. 33176. TEL: (305) 200 6701 EMAIL: nobel@ngaengineers.com KEY PLAN

<u>01 ISSUE FOR SITE PLAN REVIEW</u> <u>12. 29. 2022</u>

NOT FOR CONSTRUCTION

Consultant STAMP


> DRAWN BY CHECK BY Nobel Valencia, PE No. 72193 A.B.C.

Civil Engineer PROJECT NUMBER 2218

Drainage & **Pavement Details** 

DRAWING NO.

PAGE No. 3 OF 3

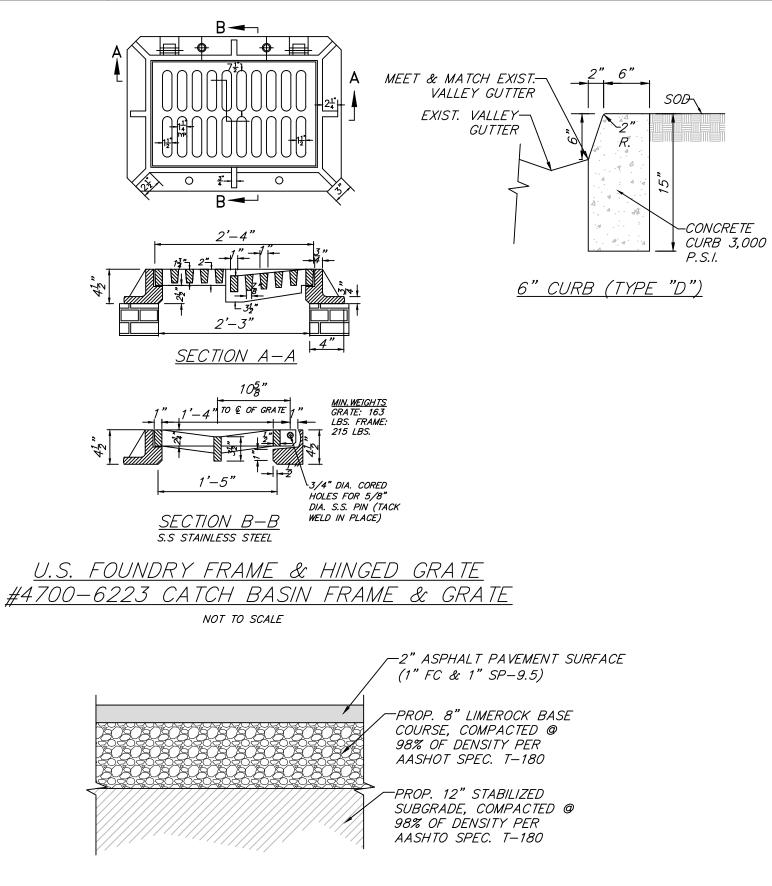



#### TRAFFIC NOTES & STANDARDS

- CONTRACTOR SHALL BE RESPONSIBLE FOR THE REMOVAL OF ALL PAVEMENT MARKINGS AND SIGNS CONFLICTING WITH THE PROPOSED CONSTRUCTION.
- 2. CONTRACTOR SHALL BE RESPONSIBLE FOR THE INSTALLATION OF ALL PAVEMENT MARKINGS AND SIGNS AS SHOWN IN THE PLANS AND APPLICABLE TRAFFIC DESIGN STANDARDS.
- 3. CONTRACTOR SHALL BE RESPONSIBLE FOR MATCHING EXISTING PAVEMENT MARKINGS AT THE PROJECT.
- 4. SIGN ASSEMBLY LOCATIONS SHOWN IN THE PLANS WHICH ARE IN CONFLICT WITH STREET LIGHTING, UTILITIES, DRIVEWAYS, PEDESTRIAN RAMPS, ETC., MAY BE ADJUSTED AS DIRECTED BY THE ENGINEER/INSPECTOR.
- 5. ALL PAVEMENT MARKINGS WITH THE EXCEPTION OF PARKING STALLS SHALL BE THERMOPLASTIC.
- 6. STRIPING AND SIGNING SHALL CONFORM WITH THE LATEST EDITION OF THE MANUAL OF UNIFORM TRAFFIC CONTROL DEVICES AND THE FLORIDA DEPARTMENT OF TRANSPORTATION DESIGN STANDARD MANUAL.

No. 72193 STATE OF CORIDA SSIONAL Y

THIS ITEM HAS BEEN DIGITALLY SIGNED AND SEALED BY NOBEL VALENCIA, P.E., ON THE DATE ADJACENT TO THE PRINTED COPIES OF THIS DOCUMENT ARE NOT CONSIDERED SIGNED AND SEALED AND THE SIGNATURE MUST BE VERIFIED ON ANY ELECTRONIC COPIES. 12/18/2022

## **ENGINEER'S CERTIFICATION:**



I HEREBY CERTIFY: That this plan was prepared under my direction and to the best of my knowledge and belief complies with the intent of the "MANUAL OF UNIFORM STANDARDS FOR DESIGN, CONSTRUCTION AND MAINTENANCE FOR STREETS, AND HIGHWAYS", as adopted Check positive response codes before you dig! by the State of Florida Legislature, Chapter 72-328 F.S.

#### **INDEX OF SHEETS**

WS-1 COVER SHEET

WS-2 WATER & SEWER PLANS & DETAILS WS-3 WATER & SEWER DETAILS

#### **DEMOLITION NOTES:**

1.- UNLESS OTHERWISE NOTED, ALL EXISTING IMPROVEMENTS WITHIN THE LIMITS OF WORK SHALL BE REMOVED IN THEIR ENTIRETY.

2.- ASPHALT PAVEMENT DESIGNATED FOR DEMOLITION SHALL BE REMOVED AND DISPOSED OF OFF-SITE AT AN APPROVED LOCATION. SAW-CUT ALL PAVEMENT EDGES WHERE EXISTING PAVEMENT IS TO REMAIN.

3.- IN GREEN AREAS, EXISTING LIMEROCK SUBBASE SHALL BE SCARIFIED TO ITS FULL DEPTH AND SHAPED TO THE LINES AND GRADES SHOWN IN THESE DRAWINGS.

4.- ALL EXISTING DRAINAGE IMPROVEMENTS WITHIN THE LIMITS OF WORK, IF ANY, SHALL BE REMOVED, INCLUDING STRUCTURES, PIPES, AND FRENCH DRAINS.

RER-DERM WATER-SEWER GENERAL NOTES:

- A HORIZONTAL DISTANCE OF AT LEAST 6 FEET, AND PREFERABLY 10 FEET (OUTSIDE TO OUTSIDE), SHALL BE MAINTAINED BETWEEN GRAVITY OR PRESSURE SEWER PIPES AND WATER PIPES. THE MINIMUM HORIZONTAL SEPARATION CAN BE REDUCED TO 3 FEET FOR VACUUM-TYPE SEWERS OR FOR GRAVITY SEWERS WHERE THE TOP OF THE SEWER PIPE IS AT LEAST 6 INCHES BELOW THE BOTTOM OF THE WATER PIPE. WHEN THE ABOVE SPECIFIED HORIZONTAL DISTANCE CRITERIA CANNOT BE MET DUE TO AN EXISTING UNDERGROUND FACILITY CONFLICT, SMALLER SEPARATIONS ARE ALLOWED IF ONE OF THE FOLLOWING IS MET:
- A) THE SEWER PIPES ARE DESIGNED AND CONSTRUCTED EQUAL TO THE WATER PIPE AND PRESSURE TESTED AT 150 PSI.
- B) THE SEWER IS ENCASED IN A WATERTIGHT CARRIER PIPE OR CONCRETE
- C) THE TOP OF THE SEWER IS AT LEAST 18 INCHES BELOW THE BOTTOM OF THE WATER PIPE. A VERTICAL DISTANCE OF AT LEAST 12 INCHES (OUTSIDE TO OUTSIDE) SHALL BE MAINTAINED BETWEEN ANY WATER AND SEWER MAINS WITH SEWER PIPES PREFERABLY CROSSING UNDER WATER MAINS. THE MINIMUM VERTICAL SEPARATION CAN BE REDUCED TO 6 INCHES FOR VACUUM-TYPE SEWERS OR FOR GRAVITY SEWERS WHERE THE SEWER PIPE IS BELOW THE WATER MAIN. THE CROSSING SHALL BE ARRANGED SO THAT ALL WATER MAIN JOINTS ARE AT LEAST 6 FEET FROM ALL JOINTS IN GRAVITY AND PRESSURE SEWER PIPES. THIS DISTANCE CAN BE REDUCED TO 3 FEET FOR VACUUM-TYPE SEWERS. WHEN THE ABOVE SPECIFIED VERTICAL DISTANCE CRITERIA CANNOT BE MET DUE TO AN EXISTING UNDERGROUND
- FACILITY CONFLICT, SMALLER SEPARATIONS ARE ALLOWED IF ONE OF THE FOLLOWING IS MET: A) THE SEWER PIPES ARE DESIGNED AND CONSTRUCTED EQUAL TO THE WATER PIPE AND PRESSURE TESTED AT 150 PSI.
- B) THE SEWER IS ENCASED IN A WATERTIGHT CARRIER PIPE OR CONCRETE AIR RELEASE VALVES SHALL BE PROVIDED AT HIGH POINTS OF NEW FORCE MAIN SANITARY SEWERS.
- GRAVITY SANITARY SEWERS CONSTRUCTED WITHIN A PUBLIC WELLFIELD PROTECTION AREA SHALL BE C-900 PVC OR DUCTILE IRON PIPE. THE MAXIMUM ALLOWABLE EXFILTRATION RATE OF GRAVITY SANITARY SEWERS CONSTRUCTED IN A PUBLIC WELLFIELD PROTECTION AREA SHALL BE:
- A) RESIDENTIAL LAND USES. FIFTY (50) GALLONS PER INCH PIPE DIAMETER PER MILE PER DAY, BASED ON A MINIMUM TWO (2) HOUR TEST HAVING A MINIMUM OF TWO (2) FEET OF POSITIVE HEAD ABOVE THE CROWN OF THE PIPE.
- B) NON-RESIDENTIAL LAND USES. TWENTY (20) GALLONS PER INCH PIPE DIAMETER PER MILE PER DAY, BASED ON A MINIMUM TWO (2) HOUR TEST HAVING A MINIMUM OF TWO (2) FEET OF POSITIVE HEAD ABOVE THE CROWN OF THE
- C) ANY OBSERVED LEAKS OR ANY OBVIOUSLY DEFECTIVE JOINTS OR PIPES SHALL BE REPLACED EVEN WHEN THE TOTAL LEAKAGE IS BELOW THAT ALLOWED.
- THE MAXIMUM ALLOWABLE EXFILTRATION RATE OF GRAVITY SANITARY SEWERS CONSTRUCTED OUTSIDE A PUBLIC WELLFIELD PROTECTION AREA SHALL BE ONE HUNDRED (100) GALLONS PER INCH PIPE DIAMETER PER MILE PER DAY, BASED ON A MINIMUM TWO (2) HOUR TEST HAVING A MINIMUM OF TWO (2) FEET OF POSITIVE HEAD ABOVE THE CROWN OF THE PIPE. ANY OBSERVED LEAKS OR ANY OBVIOUSLY DEFECTIVE JOINTS OR PIPES SHALL BE REPLACED EVEN WHEN THE TOTAL LEAKAGE IS BELOW THAT ALLOWED.
- 6. FORCEMAIN SANITARY SEWERS CONSTRUCTED WITHIN A PUBLIC WELLFIELD PROTECTION AREA SHALL BE DUCTILE IRON.
- C-900 PVC, HDPE OR REINFORCED CONCRETE PRESSURE SEWER PIPES.
- THE MAXIMUM ALLOWABLE EXFILTRATION/LEAKAGE RATE OF FORCE MAIN SANITARY SEWERS SHALL BE:
- A) DUCTILE IRON, C-900 PVC, HDPE AND PVC PIPE. THE ALLOWABLE LEAKAGE RATE SPECIFIED IN AMERICAN WATER WORKS ASSOCIATION STANDARD (AWWAS) C600-82 AT A TEST PRESSURE OF 100 PSI FOR A DURATION OF NOT LESS
- B) REINFORCED CONCRETE PRESSURE PIPE. HALF (1/2) THE ALLOWABLE LEAKAGE RATE SPECIFIED IN AWWA C600-82 AT A TEST PRESSURE OF 100 PSI FOR A DURATION OF NOT LESS THAN TWO (2) HOURS.
- C) ANY OBSERVED LEAKS OR ANY OBVIOUSLY DEFECTIVE JOINTS OR PIPES SHALL BE REPLACED EVEN WHEN THE TOTAL LEAKAGE IS BELOW THAT ALLOWED.
- 8. THE CONTRACTOR SHALL VERIFY NATURE, DEPTH, AND CHARACTER OF EXISTING UNDERGROUND UTILITIES PRIOR TO START OF CONSTRUCTION.
- 9. IN NO CASE SHALL A CONTRACTOR INSTALL UTILITY PIPES, CONDUITS, CABLES, ETC. IN THE SAME TRENCH ABOVE AN EXISTING WATER OR SEWER PIPE EXCEPT WHERE THEY CROSS
- 10. IF ANY AREA OF THE WORK SITE IS FOUND TO CONTAIN BURIED SOLID WASTE AND/OR GROUND OR GROUND WATER
- CONTAMINATION, THE FOLLOWING SHALL APPLY: A) ALL WORK IN THE AREA SHALL FOLLOW ALL APPLICABLE SAFETY REQUIREMENTS (E.G., OSHA, ETC.) AND NOTIFICATION
- MUST BE PROVIDED TO THE APPROPRIATE AGENCIES.
- B) IMMEDIATELY NOTIFY THE ENVIRONMENTAL MONITORING AND RESTORATION DIVISION (EMRD). THE EMRD CAN BE
- CONTACTED AT (305) 372-6700. C) IF CONTAMINATED SOILS AND/OR BURIED SOLID WASTE MATERIAL IS EXCAVATED DURING CONSTRUCTION, THEN THEY REQUIRE PROPER HANDLING AND DISPOSAL IN ACCORDANCE WITH THE LOCAL, STATE AND FEDERAL REGULATIONS. BE ADVISED THAT THE LANDFILL OWNER/OPERATOR IS THE FINAL AUTHORITY ON DISPOSAL AND MAY HAVE REQUIREMENTS BEYOND THOSE PROVIDED BY HEREIN. IF DISPOSAL WITHIN A MIAMI-DADE COUNTY OWNED

LANDFILL (CLASS I LANDFILL) IS APPROPRIATE AND SELECTED, PLEASE CONTACT THE MIAMI-DADE COUNTY

- DEPARTMENT OF SOLID WASTE MANAGEMENT AT (305) 594-6666 FOR INFORMATION. D) THE REUSE OF CONTAMINATED SOILS THAT ARE NOT RETURNED TO THE ORIGINAL EXCAVATION REQUIRES PRIOR APPROVAL OF A SOIL MANAGEMENT PLAN FROM THE ENVIRONMENTAL MONITORING AND RESTORATION DIVISION. THE EMRD CAN BE CONTACTED AT (305) 372-6700.
- 11. PUMPS MUST COMPLY WITH THE NATIONAL ELECTRICAL CODE (NEC) REQUIREMENTS FOR CLASS I, GROUP D, DIVISION 1 LOCATIONS (EXPLOSION PROOF).
- 12. THE CONTRACTOR IS ADVISED THAT A TREE REMOVAL/RELOCATION PERMIT MAY BE REQUIRED PRIOR TO THE REMOVAL AND/OR RELOCATION OF TREE RESOURCES. PRIOR TO REMOVING OR RELOCATING ANY TREES, THE CONTRACTOR SHALL NOTIFY THE TREE AND FOREST RESOURCES SECTION OF DERM AT (305) 372-6574 OR VIA E-MAIL AT: TFRS@MIAMIDADE.GOV, OR CONTACT THE MUNICIPALITY WITH TREE ORDINANCE JURISDICTION TO OBTAIN ANY REQUIRED PERMITS. THOSE TREES NOT INTERFERING WITH THE CONSTRUCTION SHALL BE PROTECTED IN PLACE IN ACCORDANCE WITH THE PROVISIONS OF SECTION 24-49.5 OF THE MIAMI-DADE CODE
- 13. Please note that the demolition, removal, and/or disturbance of existing underground utilities that CONTAIN ASBESTOS- CEMENT PIPES (ACP) ARE SUBJECT TO THE PROVISIONS OF 40 CFR-61 SUBPART M. THEREFORE, PURSUANT TO THE PROVISIONS OF 40 CFR-61-145, A NOTICE OF DEMOLITION OR ASBESTOS RENOVATION FORM MUST BE FILED WITH THE AIR QUALITY MANAGEMENT DIVISION (AQMD) OF DERM, AT LEAST TEN (10) WORKING DAYS PRIOR TO STARTING OF ANY WORK. NOTE THAT THE BACKFILLING AND BURIAL OF CRUSHED ACP WOULD CAUSE THESE LOCATIONS TO BE CONSIDERED ACTIVE DISPOSAL SITES AND SUBJECT TO 40 CFR-61.154, AND 40 CFR-61.151 A YEAR AFTER PROJECT COMPLETION. EXISTING STANDARD OPERATING PROCEDURES, AS WELL AS APPLICABLE FEDERAL, STATE AND LOCAL REGULATORY CRITERIA, MUST BE FOLLOWED AND IMPLEMENTED TO MINIMIZE ANY POTENTIAL RELEASE OF FUGITIVE EMISSIONS, ESPECIALLY DURING PROJECT CONSTRUCTION ACTIVITIES. THE AQMD CAN BE CONTACTED VIA EMAIL AT ASBESTOS@MIAMIDADE.GOV OR (305) 372-6925.

#### GENERAL NOTES:

- VERTICAL CONTROL POINTS AND ALL ELEVATIONS ARE BASED ON 1929 NGVD DATUM.
- THE CONTRACTOR SHALL CONFIRM ALL HORIZONTAL AND VERTICAL CONTROL POINTS PRIOR TO USE. THE CONTRACTOR SHALL CONFIRM ALIGNMENT AND ELEVATIONS OF ADJACENT WORK PRIOR TO BEGINNING CONSTRUCTION. ALL DISCREPANCIES SHALL BE IMMEDIATELY BROUGHT TO THE OWNER'S ATTENTION.
- ALL EXISTING UTILITIES SHALL REMAIN IN SERVICE, UNLESS OTHERWISE NOTED. USE EXTREME CAUTION NEAR ALL UTILITIES, CABLES, CONDUITS, AND MANHOLES. CONTRACTOR TO PROVIDE PROTECTION DURING CONSTRUCTION TO ASSURE SERVICE AT ALL TIMES. CONTRACTOR SHALL COORDINATE ALL SCHEDULES WITH FIELD
- REPRESENTATIVE PRIOR TO WORKING AROUND UTILITIES. CONTRACTOR SHALL BE RESPONSIBLE FOR BECOMING FAMILIAR WITH CURRENT SITE CONDITIONS AND SHALL REPORT ANY DISCREPANCIES ON THE PLANS TO THE ENGINEER PRIOR TO COMMENCING WORK.
- ALL CONSTRUCTION LAYOUT SHALL BE THE RESPONSIBILITY OF THE CONTRACTOR. THE CONTRACTOR SHALL BE RESPONSIBLE FOR ESTABLISHING THE WORK LIMIT LINES AS SHOWN ON THE PLANS AND SHALL WORK WITHIN THE LIMITS AND DIMENSIONS SHOWN. ALL PAVEMENT DIMENSIONS ARE TO THE EDGE OF PAVEMENT. ANY DEVIATION FROM THE PLANS SHALL REQUIRE WRITTEN APPROVAL FROM THE ENGINEER PRIOR TO EXECUTING WORK.
- GRADING SHALL CONSIST OF ALL EXCAVATION, BACKFILLING, SHAPING AND SLOPING NECESSARY FOR THE CONSTRUCTION PREPARATION AND COMPLETION OF ALL WORK AND OTHER AREAS, ALL IN ACCORDANCE WITH THE LAYOUT AND GRADES SHOWN ON THESE DRAWINGS. SAWCUT ALL PAVEMENT EDGES WHERE EXISTING PAVEMENT IS TO REMAIN
- CONTRACTOR SHALL BE RESPONSIBLE FOR PROTECTING AND RESTORING ALL ADJACENT IMPROVEMENTS. CONTRACTOR SHALL BE RESPONSIBLE FOR RESETTING ALL DISTURBED EXISTING MANHOLE COVERS, VALVE BOXES, BLOW-OFF RISERS, ETC. TO NEW ELEVATIONS. AS REQUIRED, WHETHER SPECIFICALLY SHOWN ON DRAWINGS OR NOT
- THE CONTRACTOR SHALL NOTIFY ALL UTILITY COMPANIES THAT MAY BE AFFECTED BY THE PROPOSED WORK, PRIOR TO THE START OF ANY CONSTRUCTION, TO ARRANGE FOR PHYSICAL LOCATION AND ELEVATION OF ALL UNDERGROUND IMPROVEMENTS. IT IS THE CONTRACTOR'S RESPONSIBILITY TO PROVIDE THE UTILITY COMPANY SUFFICIENT NOTICE TO SCHEDULE ANY RELOCATION OF THEIR UTILITIES. THE CONTRACTOR SHALL BE RESPONSIBLE FOR SUPPORT OF ANY UTILITY THAT MAY BE IN CONFLICT WITH OR ENDANGERED BY THE PROPOSED WORK.
- 10. ALL OVERHEAD OR SURFACE STRUCTURES AND UTILITIES ENCOUNTERED ARE TO BE CAREFULLY PROTECTED FROM DAMAGE OR DISPLACEMENT. ALL DAMAGE TO SUCH STRUCTURES SHALL BE COMPLETELY REPAIRED WITHIN THE TIME FRAME OF THE CONSTRUCTION. THE OWNER RESERVES THE RIGHT TO REMEDY SUCH DAMAGE BY ORDERING OUTSIDE PARTIES TO MAKE SUCH REPAIRS AT THE EXPENSE OF THE CONTRACTOR.
- 11. THE CONTRACTOR MAY STORE EQUIPMENT AND MATERIALS WITHIN THE LIMITS OF THE SITE. THE CONTRACTOR SHALL MAINTAIN THESE AREAS IN A CLEAN AND ORDERLY CONDITION SO AS NOT TO CAUSE A NUISANCE IN THE AREA. THE CONTRACTOR SHALL RESTORE THE STORAGE AREA TO ITS ORIGINAL OR BETTER CONDITION, WITH ALL ITS APPURTENANCES, IN KIND, TO THE SATISFACTION OF THE ENGINEER AND OWNER.
- 12. COMPLETE "AS-BUILT" INFORMATION RELATIVE TO LOCATION, SIZE AND DEPTH OF THE PROPOSED PIPES, STRUCTURES, AND OTHER IMPROVEMENTS SHALL BE ACCURATELY RECORDED. THIS INFORMATION SHALL BE SUBMITTED TO THE ENGINEER AS A CADD FILE AND AS A DRAWING SIGNED AND SEALED BY A PROFESSIONAL LAND SURVEYOR REGISTERED IN THE STATE OF FLORIDA AT THE CONTRACTOR'S EXPENSE.
- 13. THE UNDERGROUND UTILITIES SHOWN HEREON ARE BASED ON EXISTING UTILITY PLANS. NO SUBSURFACE VERIFICATION OF THE UTILITIES WAS MADE. SOME UTILITIES MAY NOT BE REFLECTED IN THESE PLANS. BEFORE EXCAVATION OR CONSTRUCTION CONTACT THE SUNSHINE ONE CALL SERVICE #811 AND THE APPROPRIATE UTILITY COMPANIES FOR FIELD VERIFICATION SUBSURFACE CASINGS, DUCT BANKS, FOOTINGS FOUNDATIONS, AND OTHER SUBSURFACE FEATURES ARE NOT LOCATED OR SHOWN HEREON ARE TO BE VERIFIED BY CONTRACTOR BEFORE COMMENCING ANY WORK.
- 14. PROVIDE 6 FOOT VINYL VISUAL BARRIER ON ALL FENCING AT CONSTRUCTION LIMITS. 15. THE CONTRACTOR SHALL BE RESPONSIBLE FOR MAINTAINING THE INTEGRITY AND MAKING THE REPAIRS OF EXISTING PAVEMENT SIDEWALKS, PIPES, CONDUITS, CURBS, CABLES, ETC., WHETHER OR NOT SHOWN ON THE PLANS, DAMAGED AS A RESULT OF THE CONTRACTOR'S OPERATIONS AND/OR THOSE OF HIS SUBCONTRACTORS, AND SHALL RESTORE THEM PROMPTLY TO THE ORIGINAL CONDITIONS OR BETTER AT NO ADDITIONAL EXPENSE TO THE OWNER. CONTRACTOR SHALL REPORT ANY DAMAGED SIDEWALK DRIVEWAY, ETC., PRIOR TO BEGINNING WORK IN ANY AREA.
- 16. EXISTING WATER METERS, UTILITY POLES & GUY WIRES AND OTHER UTILITIES WITHIN THE LIMITS OF CONSTRUCTION SHALL BE REMOVED OR RELOCATED UNLESS OTHERWISE NOTED.
- 17. ALL WORK SHALL CONFORM TO ALL APPLICABLE CODES, ORDINANCES OF TOWN OF BAY HARBOR ISLANDS STANDARDS AND DETAILS, MIAMI-DADE COUNTY STANDARDS AND DETAILS AND FLORIDA DEPARTMENT OF TRANSPORTATION STANDARDS AND
- 18. PAVEMENT RESTORATION SHALL BE IN ACCORDANCE WITH MIAMI-DADE COUNTY PUBLIC WORKS STANDARD DETAILS DETAIL

#### THE FOLLOWING ARE REQUIREMENTS PER **DEPARTMENT OF HEALTH:**

#### WATER MAIN HORIZONTAL SEPARATIONS

SEPARATIONS SHALL BE MEASURED OUTSIDE EDGE TO OUTSIDE EDGE BETWEEN WATER MAINS AND, STORM SEWERS, STORMWATER FORCE MAINS, OR RECLAIMED WATER LINES, SHALL BE 3 FT MINIMUM.

#### BETWEEN WATER MAINS AND VACUUM TYPE SEWER PREFERABLY 10 FT. AND AT LEAST 3 FT. MINIMUM.

GRAVITY OR PRESSURE SANITARY SEWERS. WASTEWATER FORCE MAINS OR RECLAIMED WATER PREFERABLY 10 FT. AND AT LEAST 6 FT. MAY BE REDUCED TO 3 FT. WHERE BOTTOM OR WATER MAINS IS AT LEAST 6 INCHES ABOVE TOP OF SEWER.

10 FT. TO ANY PART OF ON-SITE SEWER TREATMENT OR DISPOSAL SYSTEM.

#### WATER MAIN VERTICAL SEPARATIONS

SEPARATIONS BETWEEN WATER MAINS AND GRAVITY SEWER, VACUUM TYPE SEWER, OR STORM SEWERS, TO BE PREFERABLY 12 INCHES, OR AT LEAST 6 INCHES ABOVE, OR AT LEAST 12 INCHES IF BELOW.\*

PRESSURE SANITARY SEWER, WASTEWATER OR STORMWATER FORCE MAIN, OR RECLAIMED WATER, AT LEAST 12 INCHES ABOVE OR BELOW.\*

\*NOTE: CENTER 1-FULL LENGTH OF WATER MAIN PIPE AT CROSSINGS; ALTERNATIVELY ARRANGE PIPES SO JOINTS ARE AT LEAST 3 FEET FROM JOINTS IN VACUUM, STORM OR STORM FORCE MAINS, AT LEAST 6 FEET FROM JOINTS IN GRAVITY OR PRESSURE SEWERS, WASTEWATER FORCE MAINS OR RECLAIMED WATER.


#### NOTE:

#### FOR ALL PROJECTS WHERE REMOVAL OF UTILITY LINES IS PROPOSED:

1. ALL EXISTING UTILITIES BEING REMOVED AND/OR RELOCATED MUST REMAIN ACTIVE AND IN SERVICE, UNTIL SUCH TIME WHEN NEW REPLACING UTILITIES HAVE BEEN INSTALLED, IN SERVICE, ACCEPTED BY THE DEPARTMENT AND ALL RELATED SERVICES FROM THE EXISTING MAINS HAVE BEEN TRANSFERRED TO THE NEW ONES, BY A LICENSED CONTRACTOR UNDER THE SUPERVISION OF WASD LICENSED OPERATOR AND WASD DONATIONS INSPECTOR UNDER THE SCOPE AND JURISDICTION OF THE CONTRACTOR'S RIGHT-OF-WAY PERMIT.

2. ALL WATER AND/OR SEWER FACILITIES LOCATED IN PRIVATE PROPERTY SHALL BE REMOVED AFTER ALL INSTALLED SERVICES FROM THEM HAVE BEEN TRANSFERRED TO THE ALREADY INSTALLED AND IN SERVICE NEW MAINS. ANY ASSOCIATED EXCLUSIVE EASEMENTS SHALL BE CLOSED AND RELEASED AFTER THE REMOVAL OF THE EXISTING WATER AND/OR SEWER FACILITIES



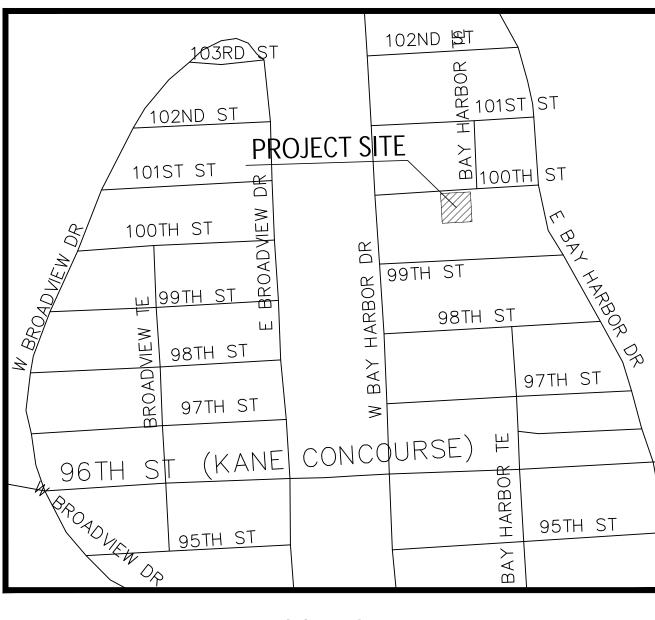

**LOCATION MAP** 

#### **LEGAL DESCRIPTION:**

LOTS 5 & 6, BLOCK 8, OF BAY HARBOR ISLAND, ACCORDING TO THE PLAT THEREOF, AS RECORDED IN PLAT BOOK 46 PAGE 5 OF THE PUBLIC RECORDS OF MIAMI-DADE COUNTY, FLORIDA

#### TRENCH SAFETY ACT

CONTRACTOR SHALL COMPLY WITH THE REQUIREMENTS OF THE "TRENCH SAFETY ACT", AND ALL REQUIREMENTS OF O.S.H.A.

### **UNDERGROUND DIGGING NOTE:**

CONTRACTOR SHALL USE EXTREME CAUTION WHEN EXCAVATING CONTRACTOR SHALL REMAIN 2 FEET AWAY FROM THE LOCATED MARKS WITH THE MACHINERY. IF IT'S NECESSARY TO EXCAVATE WITHIN THE 2 FOOT TOLERANCE ZONE, CONTRACTOR MUST HAND DIG, SOFT DIG, OR USE NON-INVASIVE MEANS TO EXPOSE AND PROTECT THE EXISTING FACILITIES AS REQUIRED BY LAW.

No. 72193

STATE OF

SONAL ENGINE

Sunshine **311** 

Call 811 or visit sunshine811.com two full

business days before digging to have

buried facilities located and marked.



Civil Engineers 11231 SW 88th St., Unit D-114, Miami, FL. 33176. TEL: (305) 200 6701 EMAIL: nobel@ngaengineers.com

THIS ITEM HAS BEEN DIGITALLY SIGNED AND SEALED BY

NOBEL VALENCIA, P.E., ON THE DATE ADJACENT TO THE

PRINTED COPIES OF THIS DOCUMENT ARE NOT CONSIDERED

SIGNED AND SEALED AND THE SIGNATURE MUST BE

I HEREBY CERTIFY: That this plan was prepared under my

direction and to the best of my knowledge and belief

complies with the intent of the "MANUAL OF UNIFORM

MAINTENANCE FOR STREETS, AND HIGHWAYS", as adopted


STANDARDS FOR DESIGN, CONSTRUCTION AND

VERIFIED ON ANY ELECTRONIC COPIES.

**ENGINEER'S CERTIFICATION:** 

12/18/2022

Check positive response codes before you dig! by the State of Florida Legislature, Chapter 72-328 F.S.

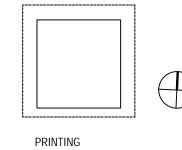

KEY PLAN

DOB APPROVAL SCAN

BHI 1130-1140 100TH ST

1130-1140 100TH STREET

FAB 314 ARCHITECTURE WORKSHOP

CARL LEVIN ARCHITECTURE + DESIGN

DEVELOPER:

DESIGNER:

REDHOEK + PARTNERS

HAYESOD STREET 2 #121

TEL AVIV-YAFO, 6816721, IL

T: 972-50-888-2629

PLISKIN ARCHITECTURE PLLC

3390 MARY STREET, SUITE 135

11231 SW 88TH ST., UNIT D-114

STRATA LANDSCAPE ARCHITECTURE

POWER & LIGHTING SYSTEMS, INC.

COCONUT GROVE, FL 33133

233 BROADWAY, SUITE 2030

NEW YORK, NY 10279

T: 212-899-9885

T: 305 442 3118

NGA ENGINEERS INC.

T: 305 200 6701

1906 TIGERTAIL AVE

3832 SHIPPING AVE.

T: 305 444 8520

DOB APPROVAL STAMP

MIAMI, FL 33146

MIAMI, FL 33133 T: 305 747 9336

LIGHTING:

MIAMI, FL 33176

LANDSCAPE:

ARCHITECT:

138 PIONEER STREET

BROOKLYN, NY 11231

T: 718.852.8162

BAY HARBOR ISLANDS, FL 33154

01 ISSUE FOR SITE PLAN REVIEW 12. 29. 2022

#### NOT FOR CONSTRUCTION Consultant

DRAWN BY CHECK BY Nobel Valencia, PE No. 72193

A.B.C. Civil Engineer PROJECT NUMBER 2218

TITLE


Cover Sheet


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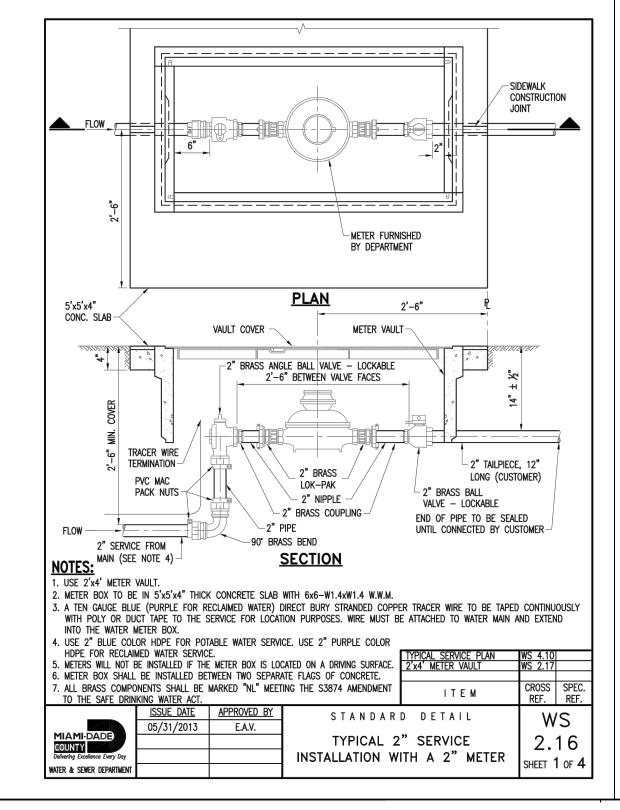
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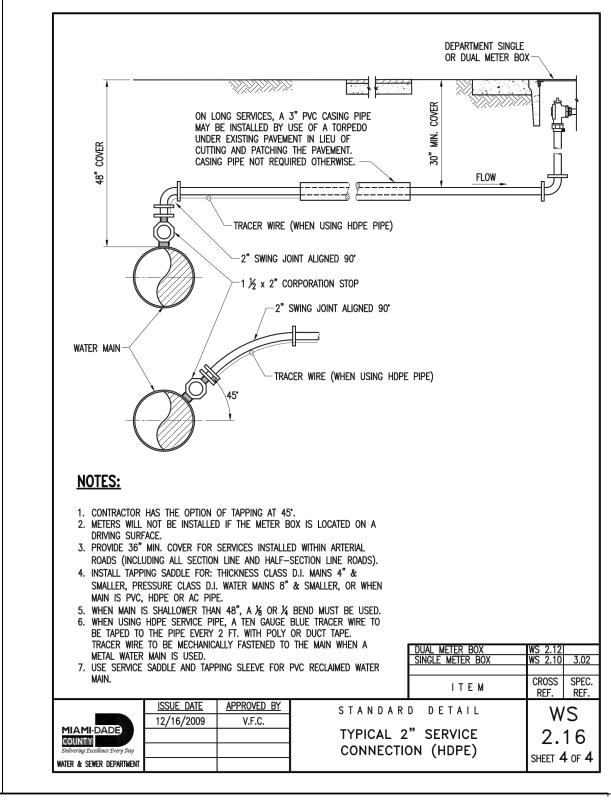
PAGE No. \_ 1 \_ 0F \_ 3

REV 04/30/2018





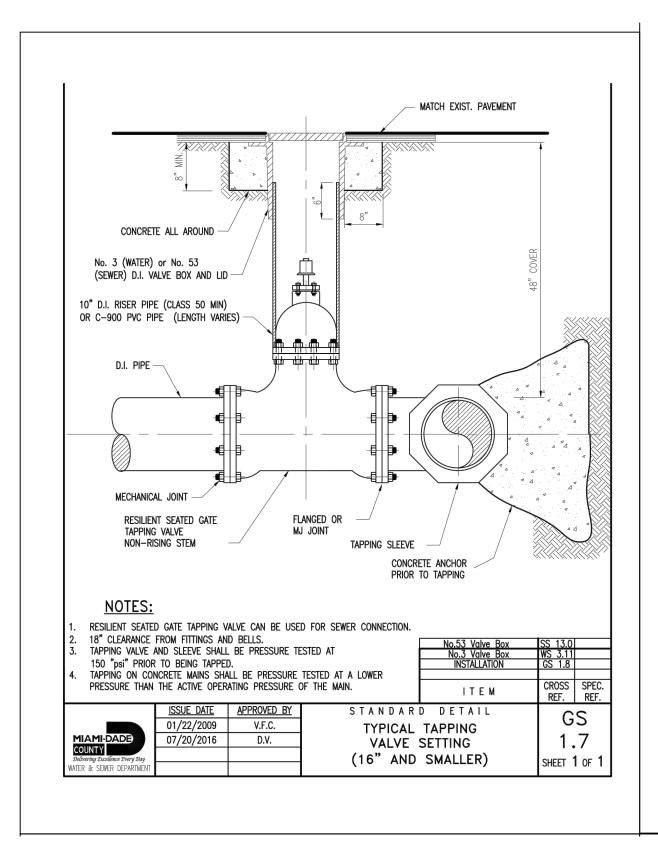

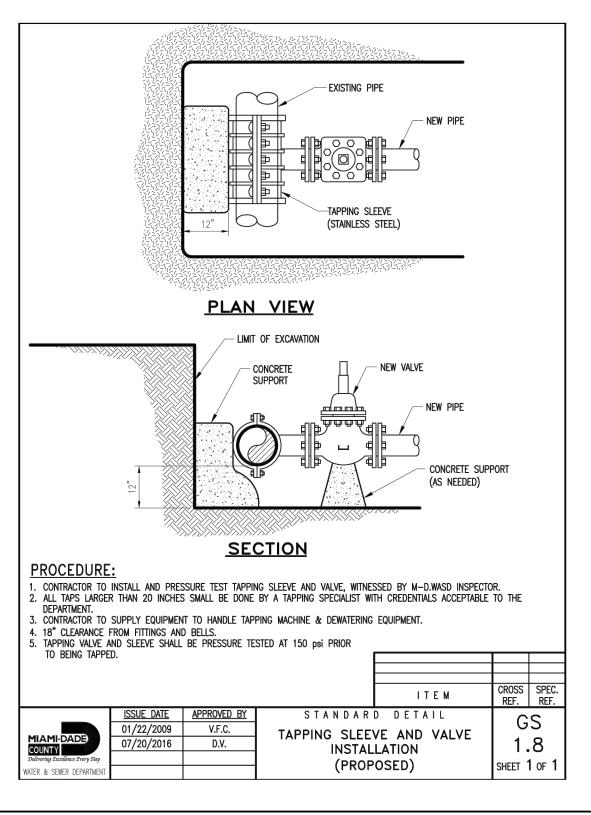

#### BHI 1130-1140 100TH ST 1130-1140 100TH STREET BAY HARBOR ISLANDS, FL 33154

DEVELOPER: REDHOEK + PARTNERS 138 PIONEER STREET BROOKLYN, NY 11231 T: 718.852.8162

DESIGNER: FAB 314 ARCHITECTURE WORKSHOP HAYESOD STREET 2 #121 TEL AVIV-YAFO, 6816721, IL

DESIGNER: PLISKIN ARCHITECTURE PLLC 233 BROADWAY, SUITE 2030 NEW YORK, NY 10279

T: 972-50-888-2629

T: 212-899-9885 ARCHITECT: CARL LEVIN ARCHITECTURE + DESIGN 3390 MARY STREET, SUITE 135

COCONUT GROVE, FL 33133 T: 305 442 3118 NGA ENGINEERS INC.

MIAMI, FL 33176 T: 305 200 6701 LANDSCAPE:

11231 SW 88TH ST., UNIT D-114


STRATA LANDSCAPE ARCHITECTURE 1906 TIGERTAIL AVE MIAMI, FL 33133 T: 305 747 9336


LIGHTING: POWER & LIGHTING SYSTEMS, INC. 3832 SHIPPING AVE. MIAMI, FL 33146 T: 305 444 8520

DOB APPROVAL STAMP

### WATER & SEWER DETAILS

NOT TO SCALE

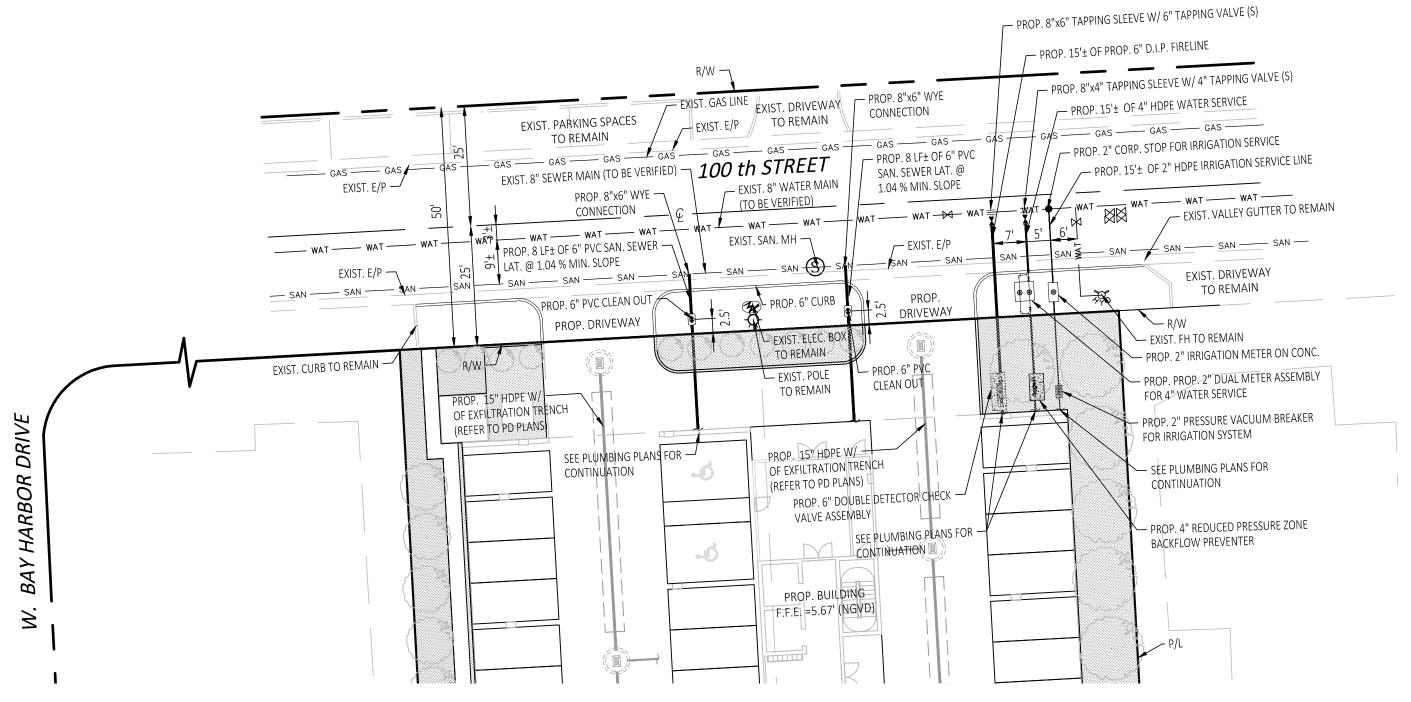

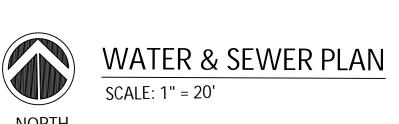



KEY PLAN

DOB APPROVAL SCAN

01 ISSUE FOR SITE PLAN REVIEW 12. 29. 2022

NOT FOR CONSTRUCTION

No. 72193 STATE OF STATE OF 12/18/2022

THIS ITEM HAS BEEN DIGITALLY SIGNED AND SEALED BY NOBEL VALENCIA, P.E., ON THE DATE ADJACENT TO THE PRINTED COPIES OF THIS DOCUMENT ARE NOT CONSIDERED SIGNED AND SEALED AND THE SIGNATURE MUST BE VERIFIED ON ANY ELECTRONIC COPIES.

**ENGINEER'S CERTIFICATION:** 



I HEREBY CERTIFY: That this plan was prepared under my direction and to the best of my knowledge and belief complies with the intent of the "MANUAL OF UNIFORM Call 811 or visit sunshine811.com two full | STANDARDS FOR DESIGN, CONSTRUCTION AND MAINTENANCE FOR STREETS, AND HIGHWAYS", as adopted Check positive response codes before you dig! by the State of Florida Legislature, Chapter 72-328 F.S.

Consultant STAMP

DRAWN BY CHECK BY Nobel Valencia, PE No. 72193 A.B.C. Civil Engineer

2218


Water & Sewer Plan & Details


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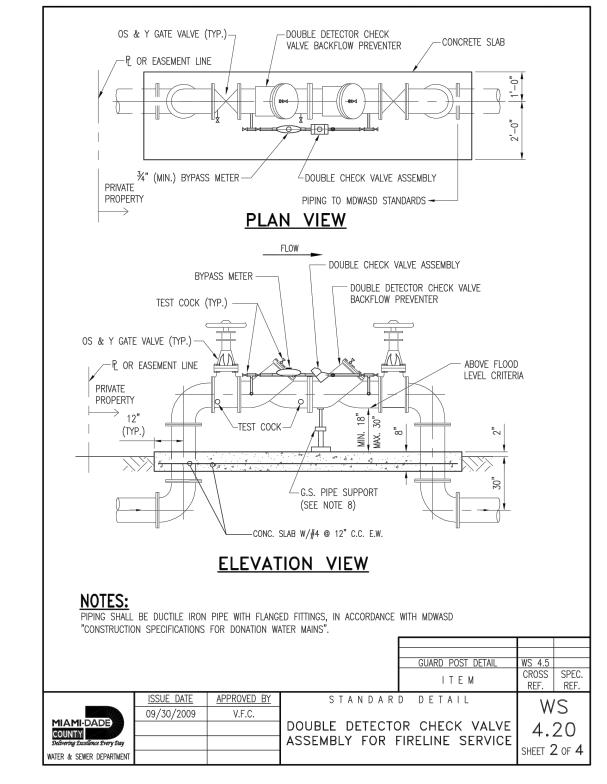
PROJECT NUMBER


WS-2

PAGE No. 2 OF 3



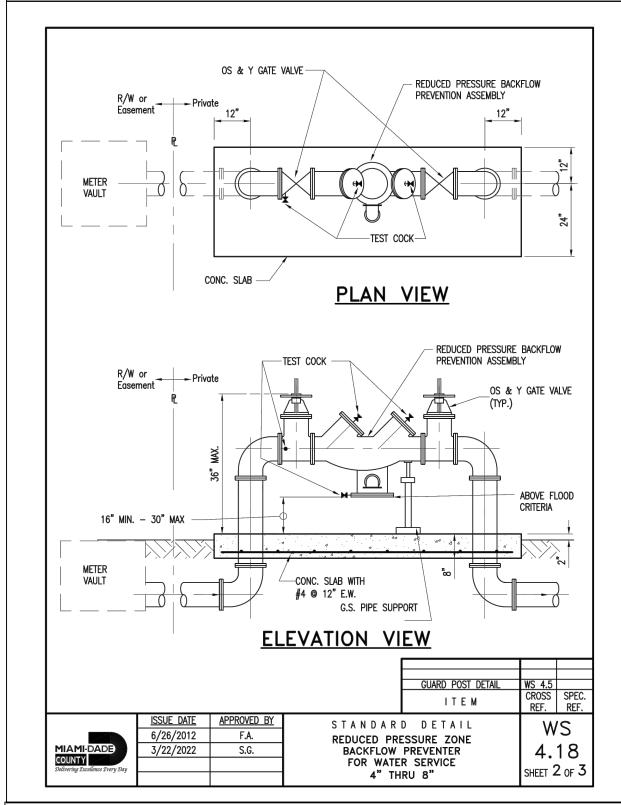

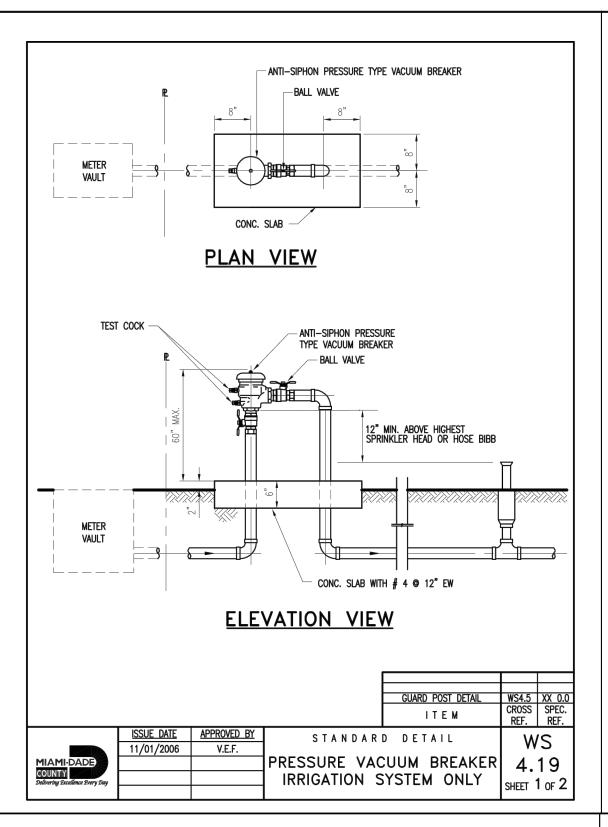

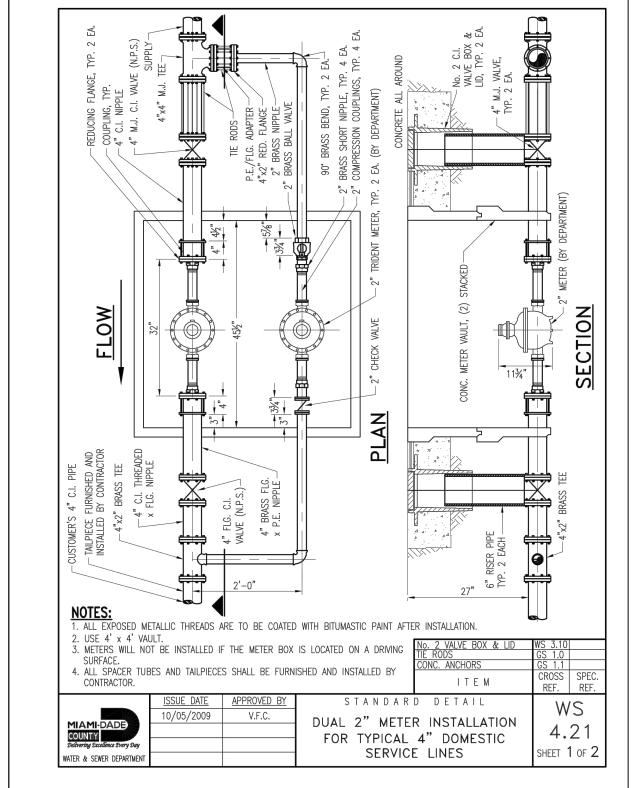

BHI 1130-1140 100TH ST 1130-1140 100TH STREET BAY HARBOR ISLANDS, FL 33154

DEVELOPER: REDHOEK + PARTNERS 138 PIONEER STREET BROOKLYN, NY 11231 T: 718.852.8162

DESIGNER: FAB 314 ARCHITECTURE WORKSHOP HAYESOD STREET 2 #121 TEL AVIV-YAFO, 6816721, IL T: 972-50-888-2629

PLISKIN ARCHITECTURE PLLC 233 BROADWAY, SUITE 2030 NEW YORK, NY 10279 T: 212-899-9885

ARCHITECT: CARL LEVIN ARCHITECTURE + DESIGN 3390 MARY STREET, SUITE 135 COCONUT GROVE, FL 33133

T: 305 442 3118 NGA ENGINEERS INC. 11231 SW 88TH ST., UNIT D-114


MIAMI, FL 33176


T: 305 200 6701 LANDSCAPE: STRATA LANDSCAPE ARCHITECTURE


1906 TIGERTAIL AVE MIAMI, FL 33133 T: 305 747 9336

LIGHTING: POWER & LIGHTING SYSTEMS, INC. 3832 SHIPPING AVE. MIAMI, FL 33146 T: 305 444 8520

DOB APPROVAL STAMP

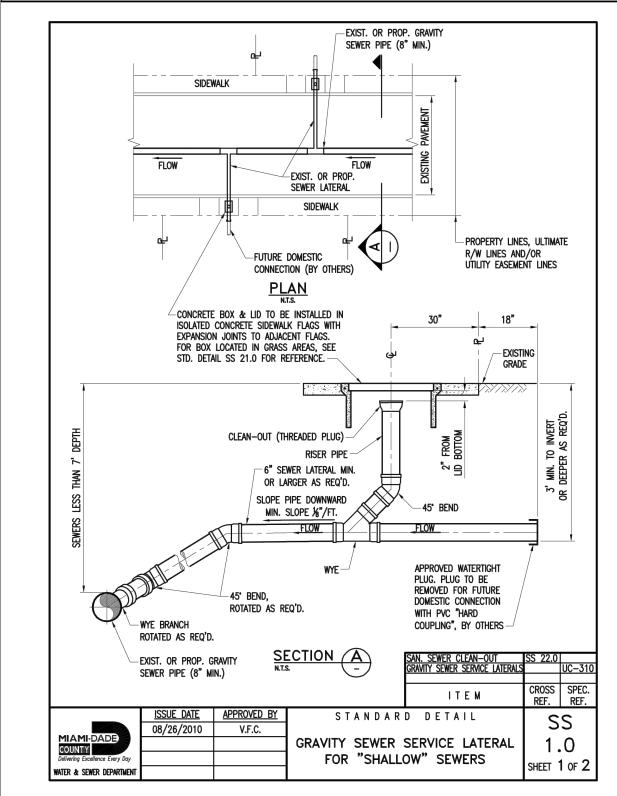

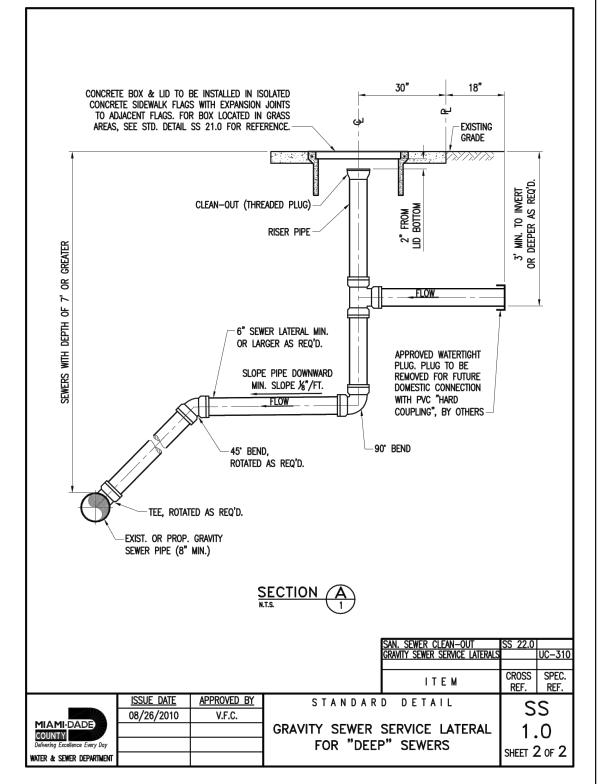


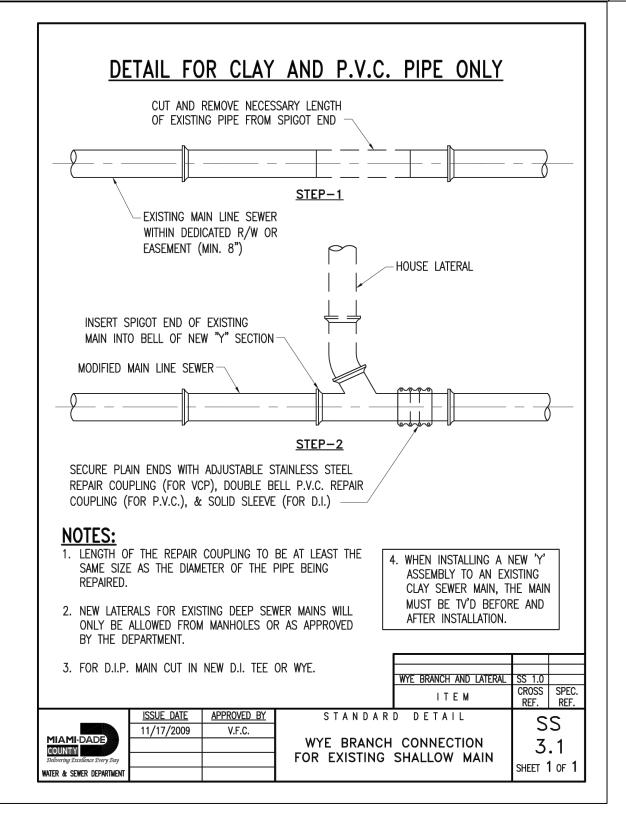

WATER & SEWER DETAILS NOT TO SCALE



11231 SW 88th St., Unit D-114, Miami, FL. 33176. TEL: (305) 200 6701 EMAIL: nobel@ngaengineers.com

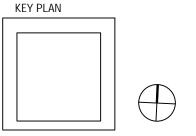

DOB APPROVAL SCAN

01 ISSUE FOR SITE PLAN REVIEW 12. 29. 2022

NOT FOR CONSTRUCTION Consultant

STAMP

CHECK BY DRAWN BY

Nobel Valencia, PE No. 72193 A.B.C. Civil Engineer PROJECT NUMBER

Water & Sewer Details

DRAWING NO.

2218

WS-3

PAGE No. 3 OF 3



VERIFIED ON ANY ELECTRONIC COPIES.

12/18/2022

THIS ITEM HAS BEEN DIGITALLY SIGNED AND SEALED BY

NOBEL VALENCIA, P.E., ON THE DATE ADJACENT TO THE

PRINTED COPIES OF THIS DOCUMENT ARE NOT CONSIDERED

SIGNED AND SEALED AND THE SIGNATURE MUST BE




STAIL OF ORIDA CHENCHE

No. 72193

I HEREBY CERTIFY: That this plan was prepared under my direction and to the best of my knowledge and belief complies with the intent of the "MANUAL OF UNIFORM Call 811 or visit sunshine811.com two full | STANDARDS FOR DESIGN, CONSTRUCTION AND MAINTENANCE FOR STREETS, AND HIGHWAYS", as adopted Check positive response codes before you dig! by the State of Florida Legislature, Chapter 72-328 F.S.

# 100th Street

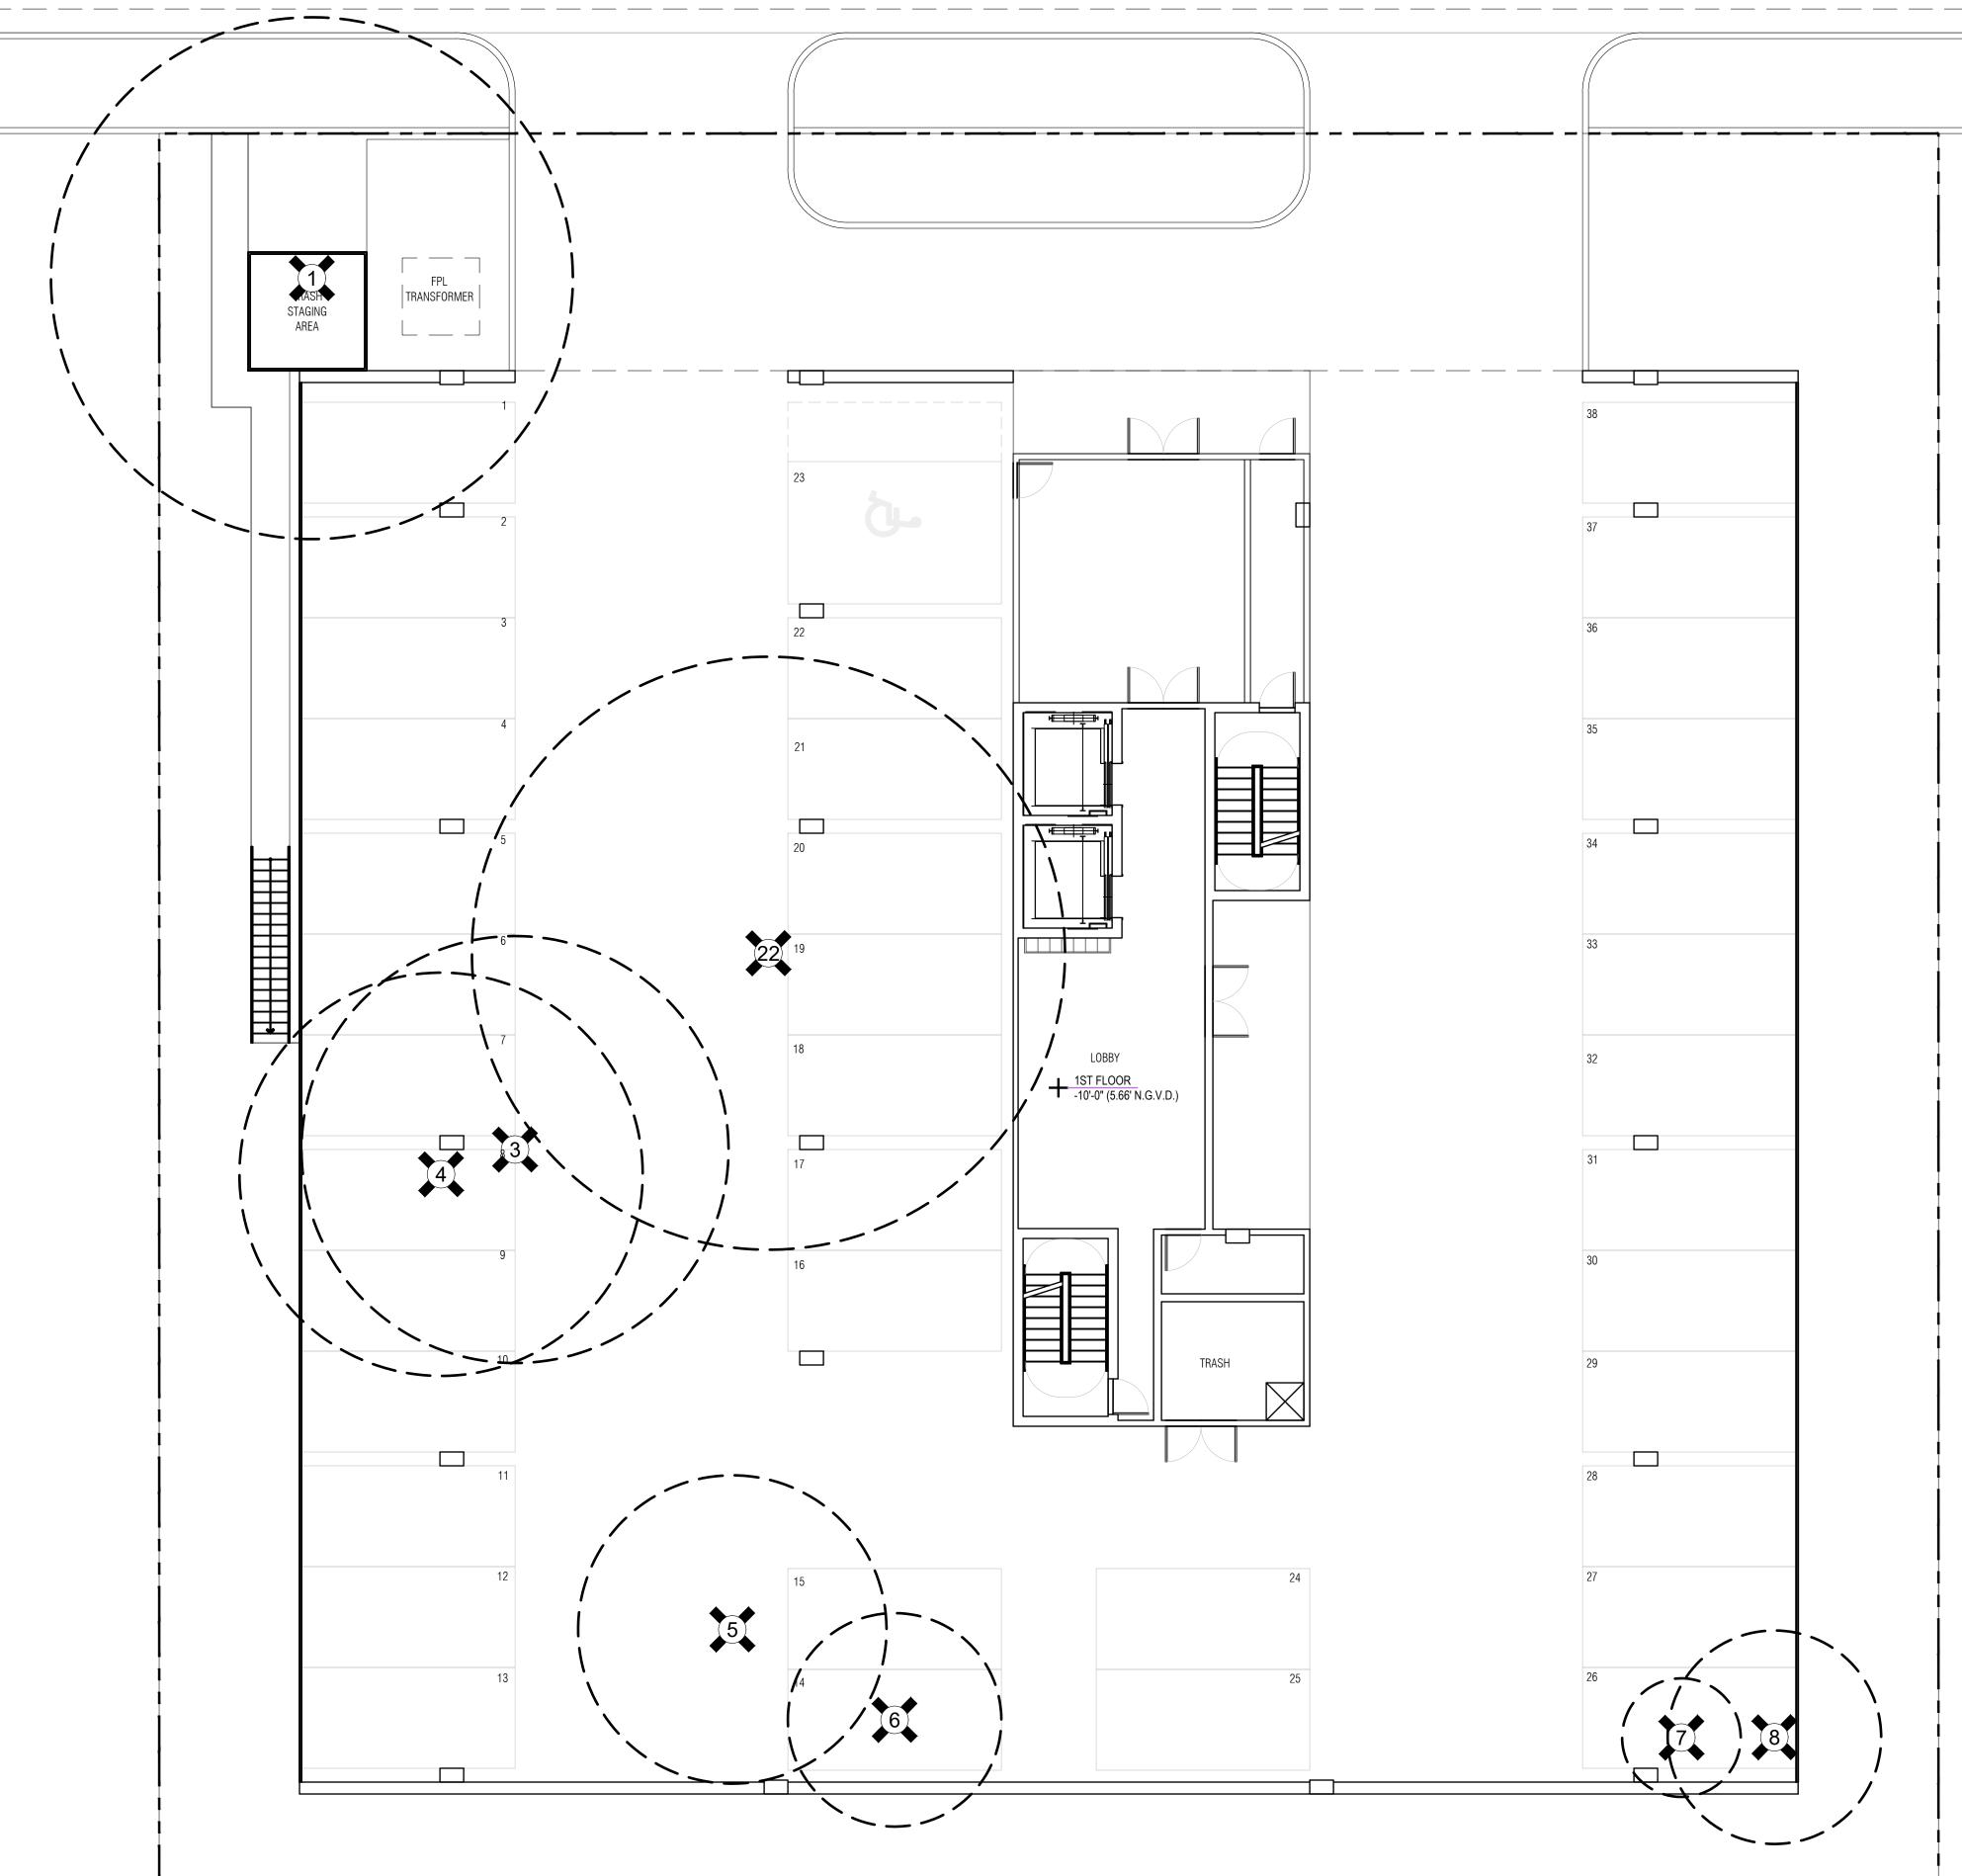

#### TREE DISPOSITION NOTES

- EXISTING TREES DESIGNATED TO REMAIN SHALL BE PROTECTED DURING ALL CONSTRUCTION PHASES. ANY TREES OR SHRUBS DESIGNATED TO REMAIN, WHICH ARE SCARRED OR DESTROYED WILL BE REPLACED AT THE CONTRACTOR'S EXPENSE, WITH SIMILAR SPECIES, SIZE AND QUALITY.
- CONTRACTOR'S EXPENSE, WITH SIMILAR SPECIES, SIZE AND QUALIT REFER TO AND COORDINATE WITH TREE DISPOSITION LIST. CONTRACTOR SHALL ORTAIN ALL REQUIRED TREE REMOVAL / RELOC
- PERMITS PRIOR TO THE COMMENCEMENT OF WORK.


  4. GENERAL CONTRACTOR SHALL BE RESPONSIBLE TO VERIFY ALL EXISTING
- TREES PRIOR TO COMMENCEMENT OF WORK.

  GENERAL CONTRACTOR SHALL BE RESPONSIBLE TO PROPERLY SECURE ALL

GENERAL CONTRACTOR SHALL BE RESPONSIBLE TO PROPERLY SECURE ALL	
PORTIONS OF THE SITE DURING TREE REMOVAL / RELOCATION PROCESS.	

Tree #	Common Name	Botanical Name	DBH (inches)	Height (feet)	Canopy Diameter (feet)	TPZ Radius (feet)	Condition	Disposition Status
1	Melaleuca	Melaleuca quinquenervia	85	33	45	71	Moderate	Remove
2	Strangler Fig	Ficus aurea	72	34	50	60	Moderate	Remove
3	Strangler Fig	Ficus aurea	30	35	35	25	Moderate	Remove
4	Melaleuca	Melaleuca quinquenervia	30	35	35	25	Poor	Remove
5	Mango Tree	Mangifera indica	27	18	26	23	Moderate	Remove
6	Brazilian Pepper	Schinus terebinthifolia	15	20	18	13	Poor	Remove
7	Strangler Fig	Ficus aurea	5	22	10	4	Poor	Remove
8	Carrotwood	Cupaniopsis anacardiodes	10	24	18	8	Poor	Remove

#### **GRAPHIC LEGEND**

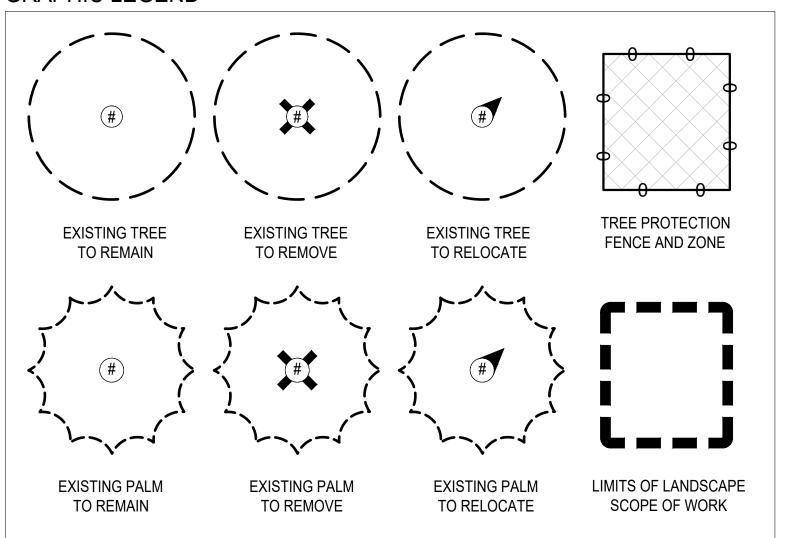

LANDSCAPE ARCHITECTUR 1906 Tigertail Ave. Miami, FL 3313: strata-landarch.com | 305.747.933

100TH ST

Oth St, Bay Harbor Islands, FL

T ADDRESS:

SEAL:

SEAL:

LANDSCAAL

LA6667526

- \* - STATE

OF

STATE

OF

Petar Stracenski, RLA #LA6667526

PROJECT NO: 71\_22

PHASE: PERMITING

PHASE: PERMITING

DATE: 12/20/2022

DRAWN:

CHECKED: P.

TREE DISPOSITION

SHEET NO.

16 SHEET NO.


SCALE: 1/8"=1'-0"



1ST FLOOR PLANT LIST					
ABBR.	QTY.	BOTANICAL NAME	COMMON NAME	SPECIFICATIONS	
STREET T	REES				
Qvi	4	Quercus virginiana	Southern Live Oak	3" DBH 16' Ht. Min. 6' CT	
TREES					
Ce	4	Conocarpus Erectus	Green Buttonwood	5" DBH 18'-20' Ht. Min. 4' C	
Ce2	10	Conocarpus Erectus	Green Buttonwood	4" DBH 14'-16' Ht. Min. 4' C	
Bsi	8	Bursera simaruba	Gumbo Limbo	4" DBH 14'-16' Ht. Min. 4' C	
Cdi	11	Coccoloba diversifolia	Pigeon Plum Tree	4" DBH 14'-16' Ht. Min. 4' C	
Efo	6	Eugenia foetida	Spanish Stopper	2" DBH 12' Ht. Min. 4' CT	
PALMS					
Rel	4	Roystonea elata	Royal Palm	20'-28' Ht. O.A.	
Spa2	5	Sabal palmetto	Sabal Palm (crooked trunk)	14'-18' Ht. OA	
SHRUBS					
Sr	10	Serenoa repens 'Silver Form'	Silver Saw Palmetto	15 Gal. 36" Ht.	
Cac	15	Capparis cynophallophora	Jamaican Caper	15 Gal. 36" Ht.	
Pn	40	Psychotria nervosa	Wild Coffee	15 Gal. 36" Ht.	
Fm	30	Ficus microcarpa	Green Island Ficus	7 Gal. 18" Ht.	
Cic	45	Chrysobalanus icaco	Redtip Cocoplum	15 Gal. 36" Ht.	
NUMBER	AND TY	PE OF GROUNDCOVERS TO BE	DETERMINED DURING TH	E NEXT DESIGN PHASE	

	Fown of Bay Harbor Isla  Landscape Requireme	ents Legend	DM 0)
	y Residential / Townhouse e Code (Sec. 24-16) & Miami-Dad		
Site Address Legal Description	1130-1140 100TH St, Bay l Lot 5 & 6, Block 8 of Bay l		
Net Lot Area <u>0.5165</u>	Acres /22,500SF		
I. Open Space Requi	romant	Required	Provided
1. Net Lot Area = 22,5		20% / 4,500 SF	24% / 5,430
(BHI – Sec. 23-11)		<u>20 % / 4,300 31°</u>	24 /0 / 3,430
2. Maximum Lawn Are (MDC – Sec. 18A- a. Req. open space 4,50	6(A)(5))	60% Max / 2,700 SF	4 % / 900 \$
II. Shade Trees			
A. Required			
	e: 28 x 0.5165 acres = 14 / 4' clear wood / 2 ½' caliper)	14	39
	tuted at a 3:1 ratio; max. 25% of re 6(C)(5)) and BHI Sec. 24-16	quired shade trees)	
2. Native Species Req # of shade trees req. 7 (BHI – Sec. 24-16)	x 50% = 4	7	39
3. Drought Tolerant ar Maintenance Specie # of shade trees req. 7x (MDC – Sec. 18A-	es Require – 50% Min. : 50% = 4	7	39
B. Tree Species			
1. Number of shade tro (from Sec. (II)(A)(1		14	
2. Number of shade tro (BHI – Sec. 24-16)		4	4
C. Tree Heights			
Number of Stories of Stories of Stories of Shade transfer of Sec. (II)(A)(**	ees required14		
3. Shade tree heights	required: 12 ft <u>0</u>	% or0 sha	ade trees
	14-16 ft <u>25</u>	% or <u>3</u> sh	ade trees
	16-18 ft <u>50</u>	_% or <u>7</u> sha	ide trees
	18-20 ft <u>25</u>	% or <u>4</u> s	shade trees
III. Street Trees		Required	Provide
(Street tree specie	= 2.85 6' clear wood / 2 ½" caliper) es determined by Street Tree Mast ot count toward required on site sh		4
IV. Shrubs Required		Required	Provide
1. 10 shrubs required (Min. 24" in height (BHI – Sec. 24-16	/ visual screen min. 36" in height	140 / max 24" on center)	140
2. Native Species Rec (MDC – Sec. 18A-	•	42	60
	nd Low es Required – 50% Min. <sup>.6(D)(1)(b))</sup>	70	140

SCALE: 1/8"=1'-0"

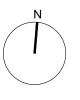

100TH

PROJECT NO: 71\_22 PHASE: PERMITING DATE: 12/20/2022

CHECKED:

FIRST FLOOR **PLANTING PLAN** 



	3RD FLOOR PLANT LIST						
ABBR.	QTY.	BOTANICAL NAME	COMMON NAME	SPECIFICATIONS			
PALMS							
Cmi	2	Coccothrinax miraguama	Miraguama Palm	6'-10' Ht. OA			
Car	2	Coccothrinax argentata	Florida Silver Palm	4'-6' Ht. OA			
Ccr	2	Coccothrinax crinita	Old Man Palm	4'-6' Ht. OA			
NUMBER	AND TY	<b>PE OF GROUNDCOVERS TO</b>	<b>BE DETERMINED DURING TI</b>	HE NEXT DESIGN PHASE			

SET AND SCAPE ARCHITECTURE 1906 Tigertail Ave. Miami, FL 33133 strata-landarch.com | 305.747.9336

II 1130-40 100TH ST

PROJECT ADDRESS:

DESCRIPTION

SEAL:

ANDSCAPILITY STRACE PARTIES OF

Peter Stracenski Pl A #1 A6667526

Petar Stracenski, RLA #LA666752 PROJECT NO: 71\_22 PHASE: PERMITING DATE: 12/20/2022

DATE: 12/20/2022

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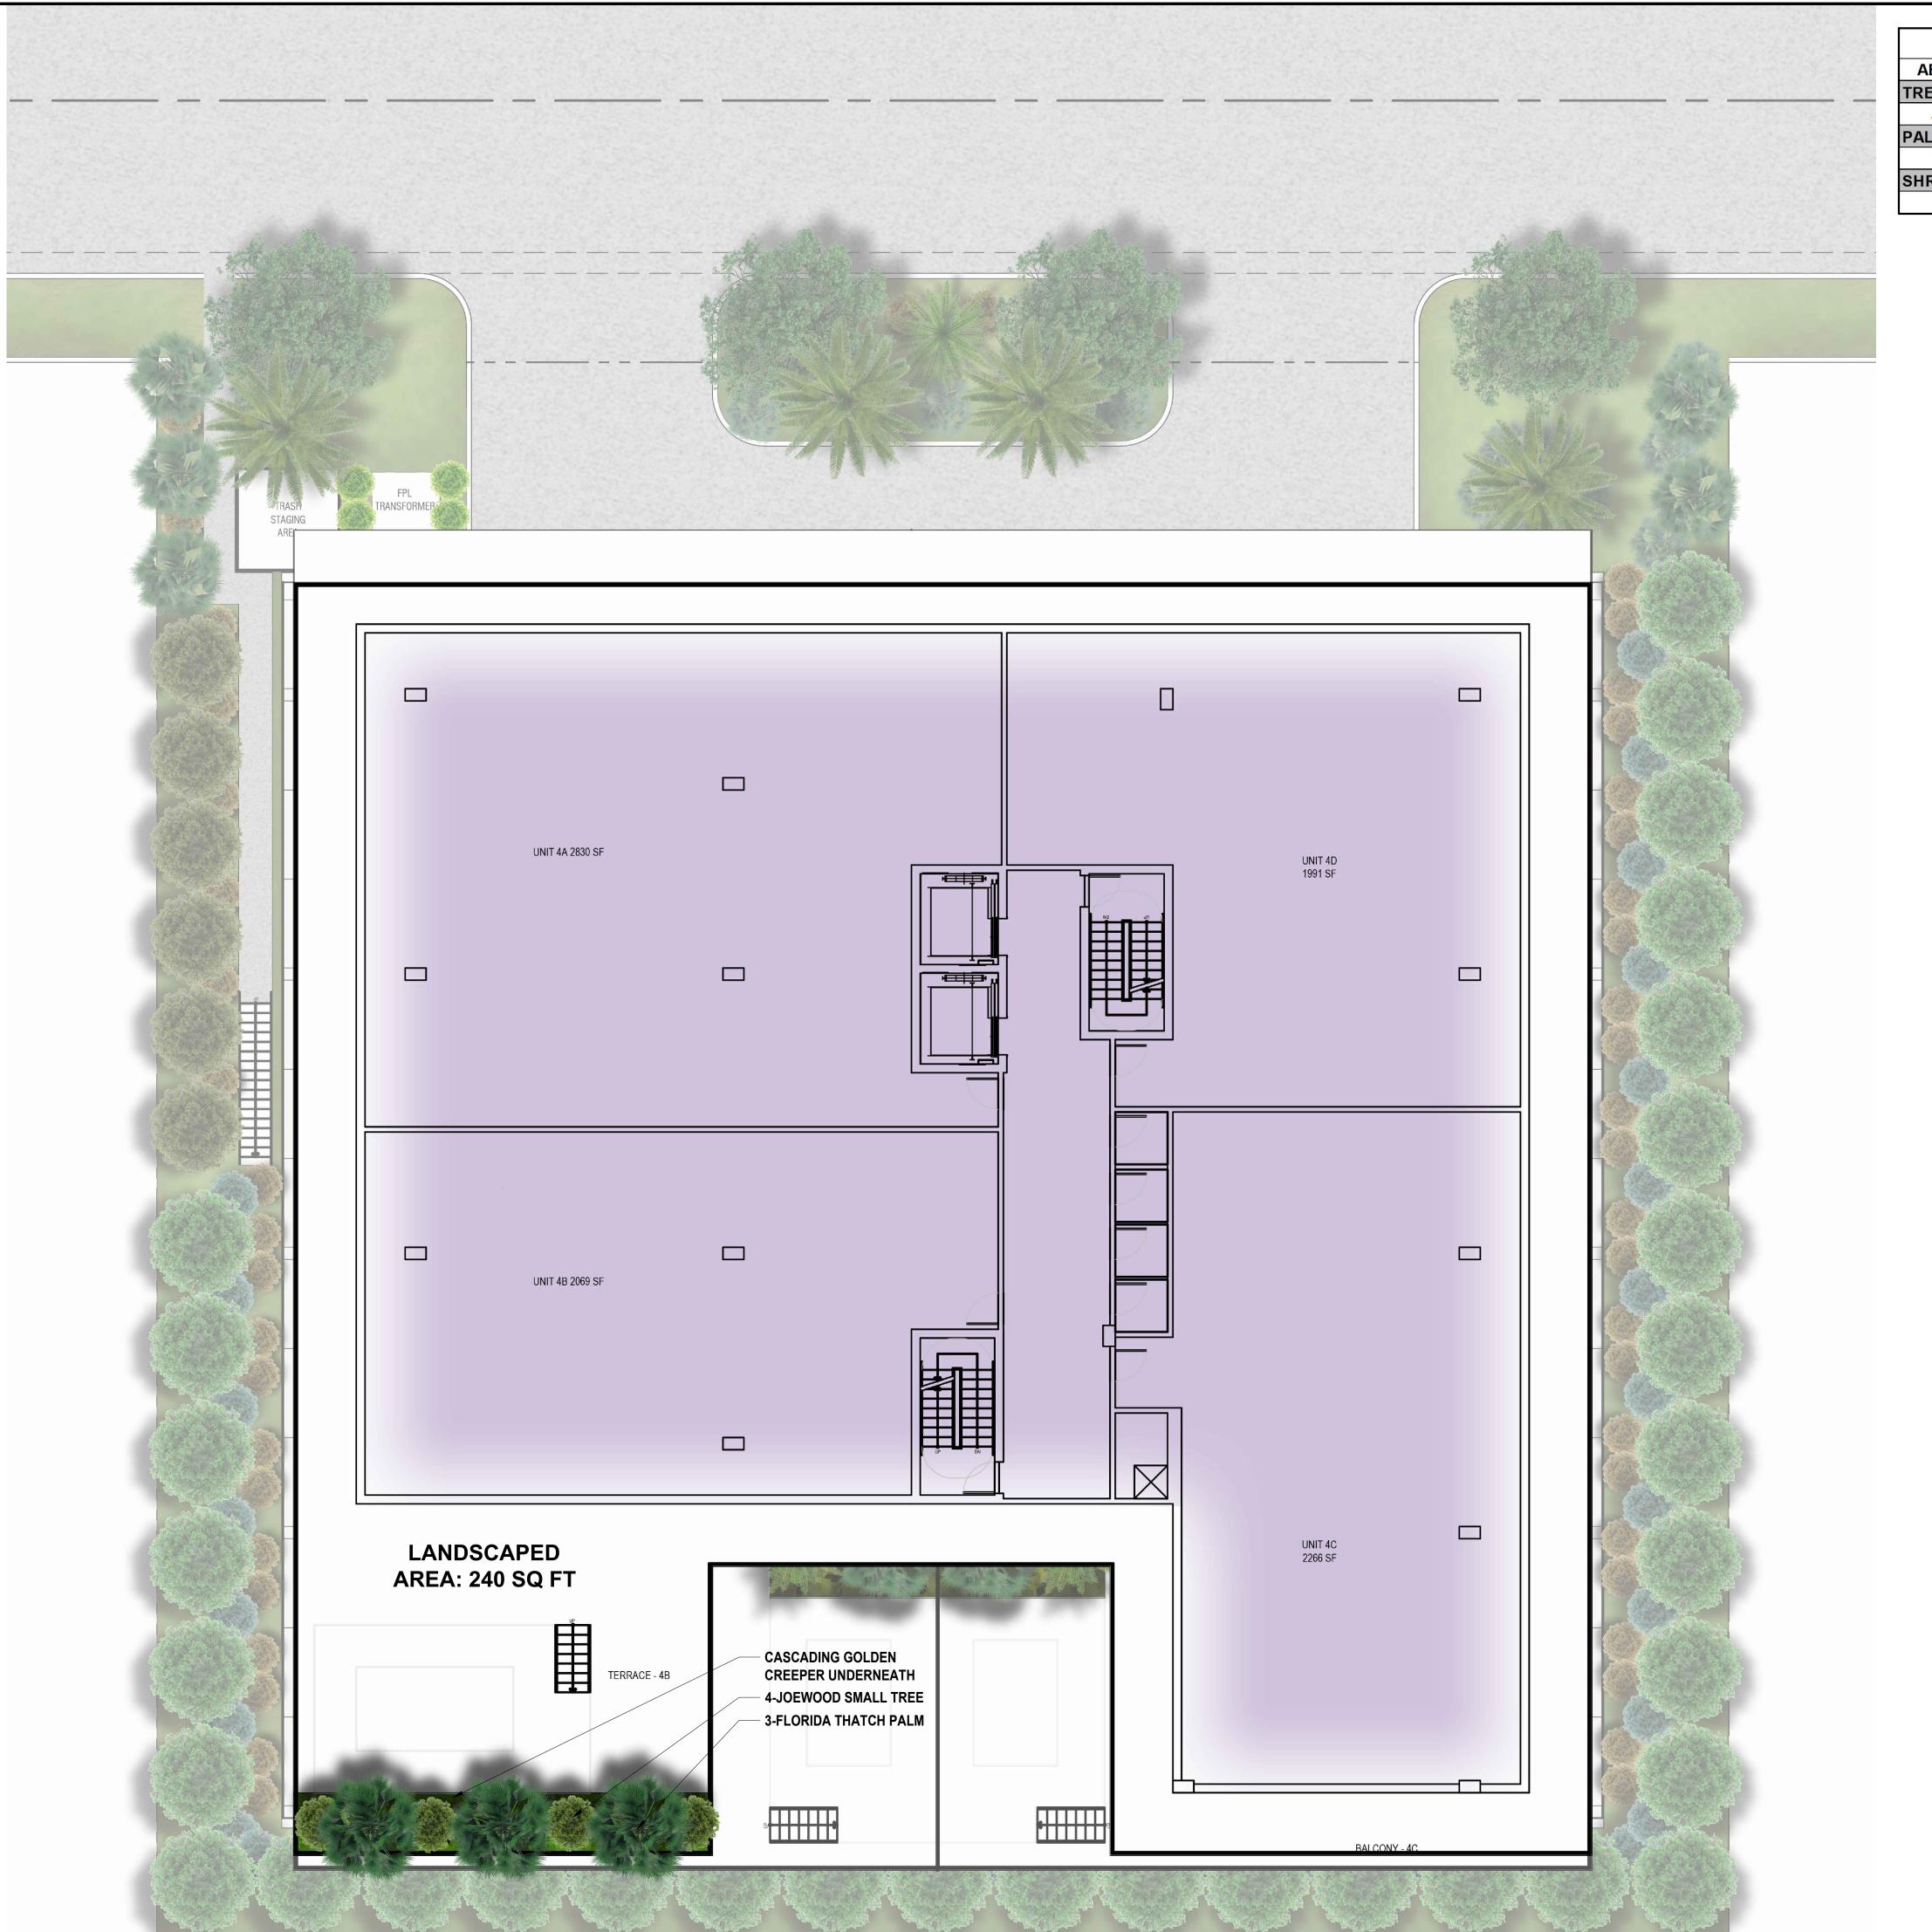
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SHEET TITLE:

3RD FLOOR
PLANTING PLAN

HEET NO.

8' 0 8 16 SCALE: 1/8"=1'-0"



	4TH FLOOR PLANT LIST						
ABBR.	QTY.	BOTANICAL NAME	COMMON NAME	SPECIFICATIONS			
TREES	•						
Jac	4	Jacquinia keyensis	Joewood Tree	25 Gal. Sculptural			
PALMS							
Tra	3	Thrinax radiata	Florida Thatch Palm	6'-10' Ht. OA			
SHRUBS							
El	TBD	Ernodea littoralis	Golden Creeper	1 Gal.			

100TH

LA6667526

PROJECT NO: 71\_22 PHASE: PERMITING DATE: 12/20/2022 DRAWN:

CHECKED:

4TH FLOOR **PLANTING PLAN** 

SCALE: 1/8"=1'-0"




	5TH FLOOR PLANT LIST					
ABBR.	QTY.	BOTANICAL NAME	COMMON NAME	SPECIFICATIONS		
TREES						
Jac	7	Jacquinia keyensis	Joewood Tree	25 Gal. Sculptural		
PALMS						
Tra	9	Thrinax radiata	Florida Thatch Palm	6'-10' Ht. OA		
SHRUBS						
EI	TBD	Ernodea littoralis	Golden Creeper	1 Gal.		

ANDSCAPE ARCHITECTURE
306 Tigertail Ave. Miami, FL 33133

130-40 100TH ST

PROJECT ADDRESS:

EV. DATE DESCRIPTION

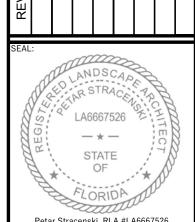

Petar Stracenski, RLA #LA666752

PROJECT NO: 71\_22

PHASE: PERMITING

DATE: 12/20/2022

DRAWN:
CHECKED:

5TH FLOOR
PLANTING PLAN


SHEET NO.

8' 0 8 16 SCALE: 1/8"=1'-0"



	TILELOOD DI ANTILIOT							
	7TH FLOOR PLANT LIST							
ABBR.	QTY.	BOTANICAL NAME	COMMON NAME	SPECIFICATIONS				
PALMS								
Cmi	5	Coccothrinax miraguama	Miraguama Palm	6'-10' Ht. OA				
SHRUBS								
El	TBD	Ernodea littoralis	Golden Creeper	1 Gal.				
ACCENTS	•		·					
Aat	6	Agave attenuata	Spineless Agave	3 Gal.				

100TH

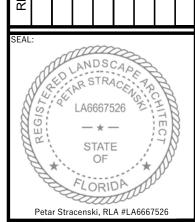


PROJECT NO: 71\_22 PHASE: PERMITING DATE: 12/20/2022


DRAWN: CHECKED:

7TH FLOOR

**PLANTING PLAN** 

L.06

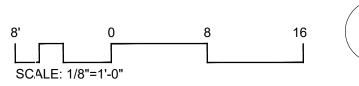

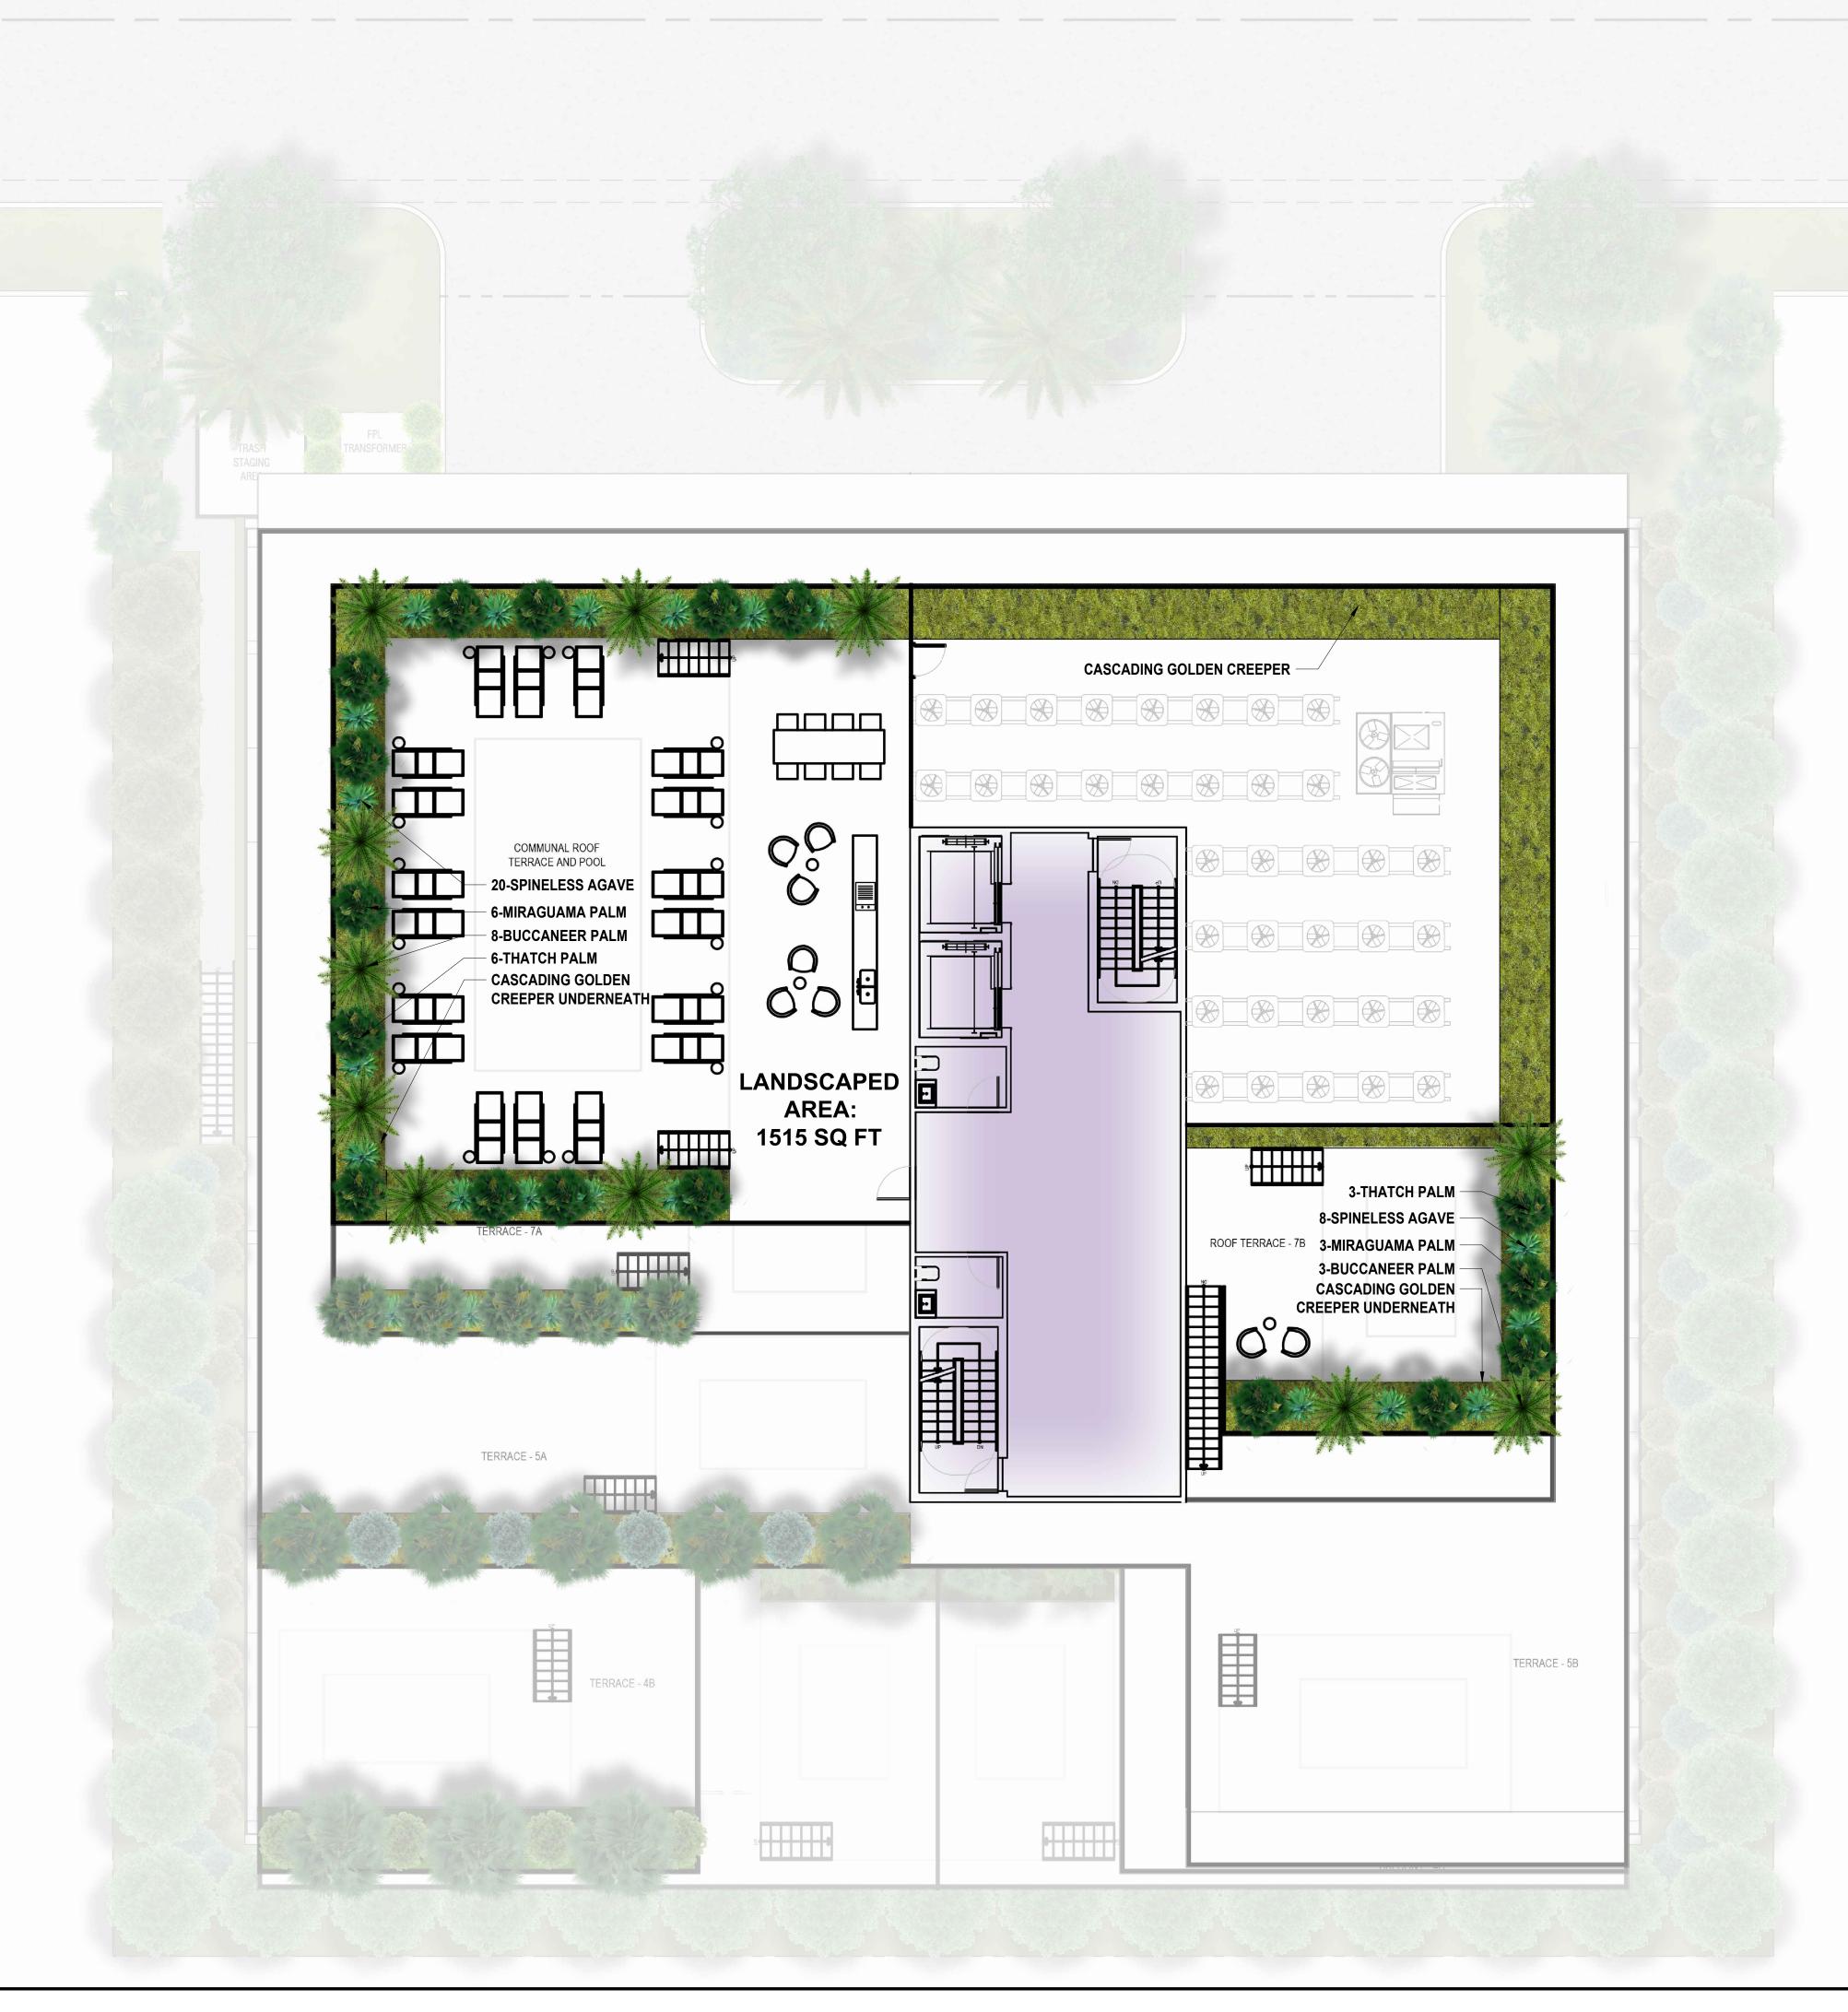

ROOF TERRACE PLANT LIST						
ABBR.	QTY.	BOTANICAL NAME	COMMON NAME	SPECIFICATIONS		
PALMS						
Cmi	9	Coccothrinax miraguama	Miraguama Palm	6'-10' Ht. OA		
Tra	9	Thrinax radiata	Florida Thatch Palm	6'-10' Ht. OA		
Psa	11	Pseudophoenix sargenti	Buccaneer Palm	6'-10' Ht. OA		
SHRUBS						
EI	TBD	Ernodea littoralis	Golden Creeper	1 Gal.		
ACCENTS						
Aat	28	Agave attenuata	Spineless Agave	3 Gal.		




LANDSCAPE ARCH 1906 Tigertail Ave. Mia strata-landarch.com

130-40 100TH ST

1130-1140 100th St,

REV. DATE DESCRIPTION

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Petar Stracenski, RLA #LA6667526

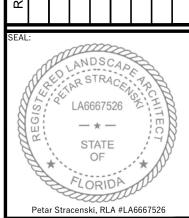PROJECT NO: 71\_22

PHASE: PERMITING

PHASE: PERMITING

DATE: 12/20/2022

DRAWN:

CHECKED:

SHEET TITLE:

ROOF TERRACE PLANTING PLAN

SHEET NO.
L.07

8' 0 8 10 SCALE: 1/8"=1'-0"

CHECKED:

**PLANTING PALETTE** 


L.08



Southern Live Oak Quercus virginiana




Pimenta racemosa

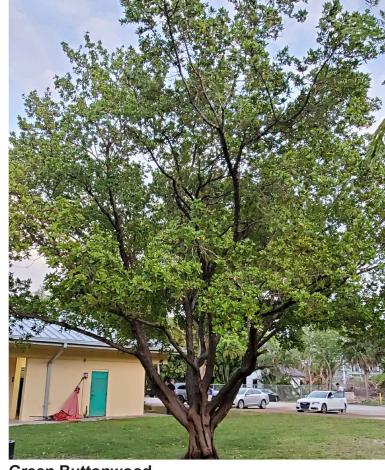

Green Buttonwood Conocarpus Erectus



Silver Buttonwood Conocarpus erectus var. sericeus

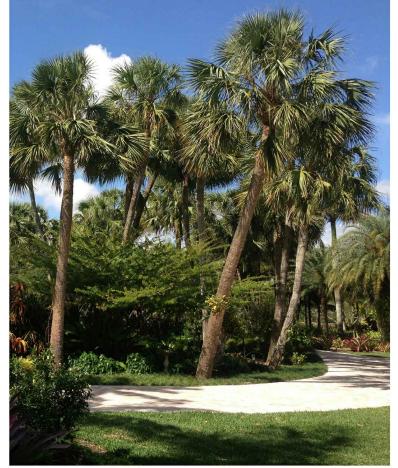

Sabal Palm



Silver Saw Palmetto Serenoa repens 'Silver Form'



Brazilian Beautyleaf Calophyllum brasiliense



Spanish Stopper
Eugenia foetida



Royal Palm Roystonea elata



Hurricane Palm Dictyosperma album



Green Island Ficus
Ficus microcarpa



**Trinette**Schefflera arboricola 'Trinette'



Florida Silver Palm Coccothrinax argentata




Old Man Palm Coccothrinax crinita



Guano Palm Coccothrinax borhidiana



Golden Creeper Ernodea littoralis

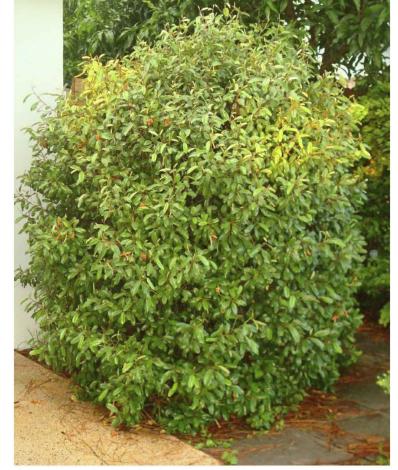

Jamaican Caper Capparis cynophallophora




Psychotria nervosa




Vietnam leaf flower Phyllanthus cochinchinensis



Spineless Agave
Agave attenuata

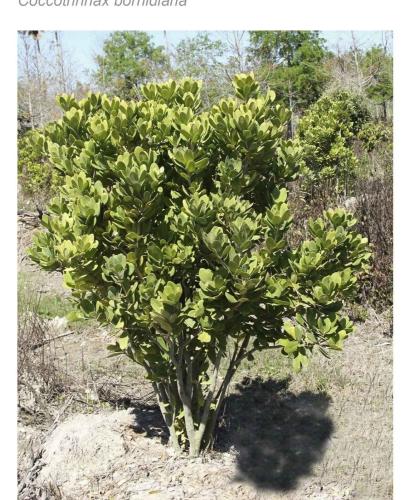

Jacquinia arborea
Braceletwood

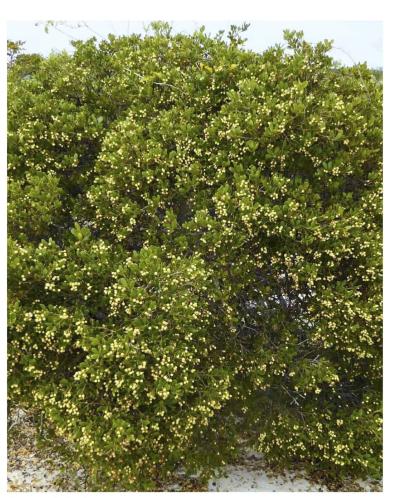

Jacquinia keyensis
Joewood



Redtip Cocoplum Chrysobalanus icaco



Miraguama Palm Coccothrinax miraguama